


SITE PLAN (PROPOSED)


SCALE - 1" = 20'-0"



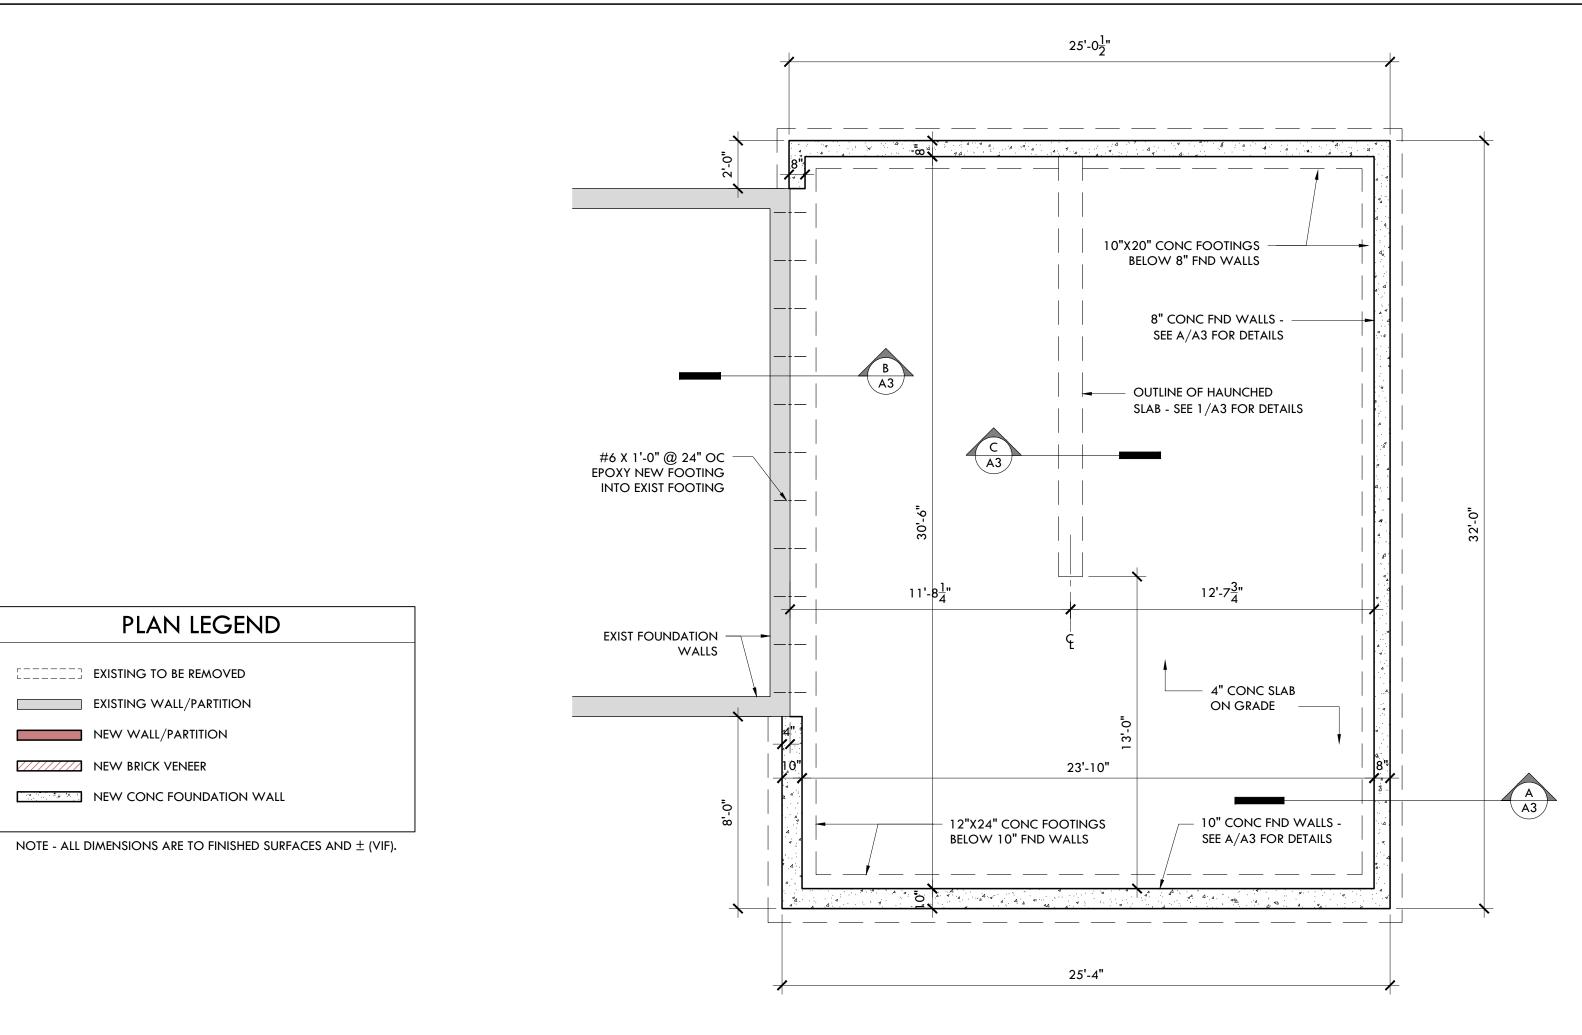

FOUNDATION PLAN

SCALE - $\frac{1}{4}$ " = 1'-0"

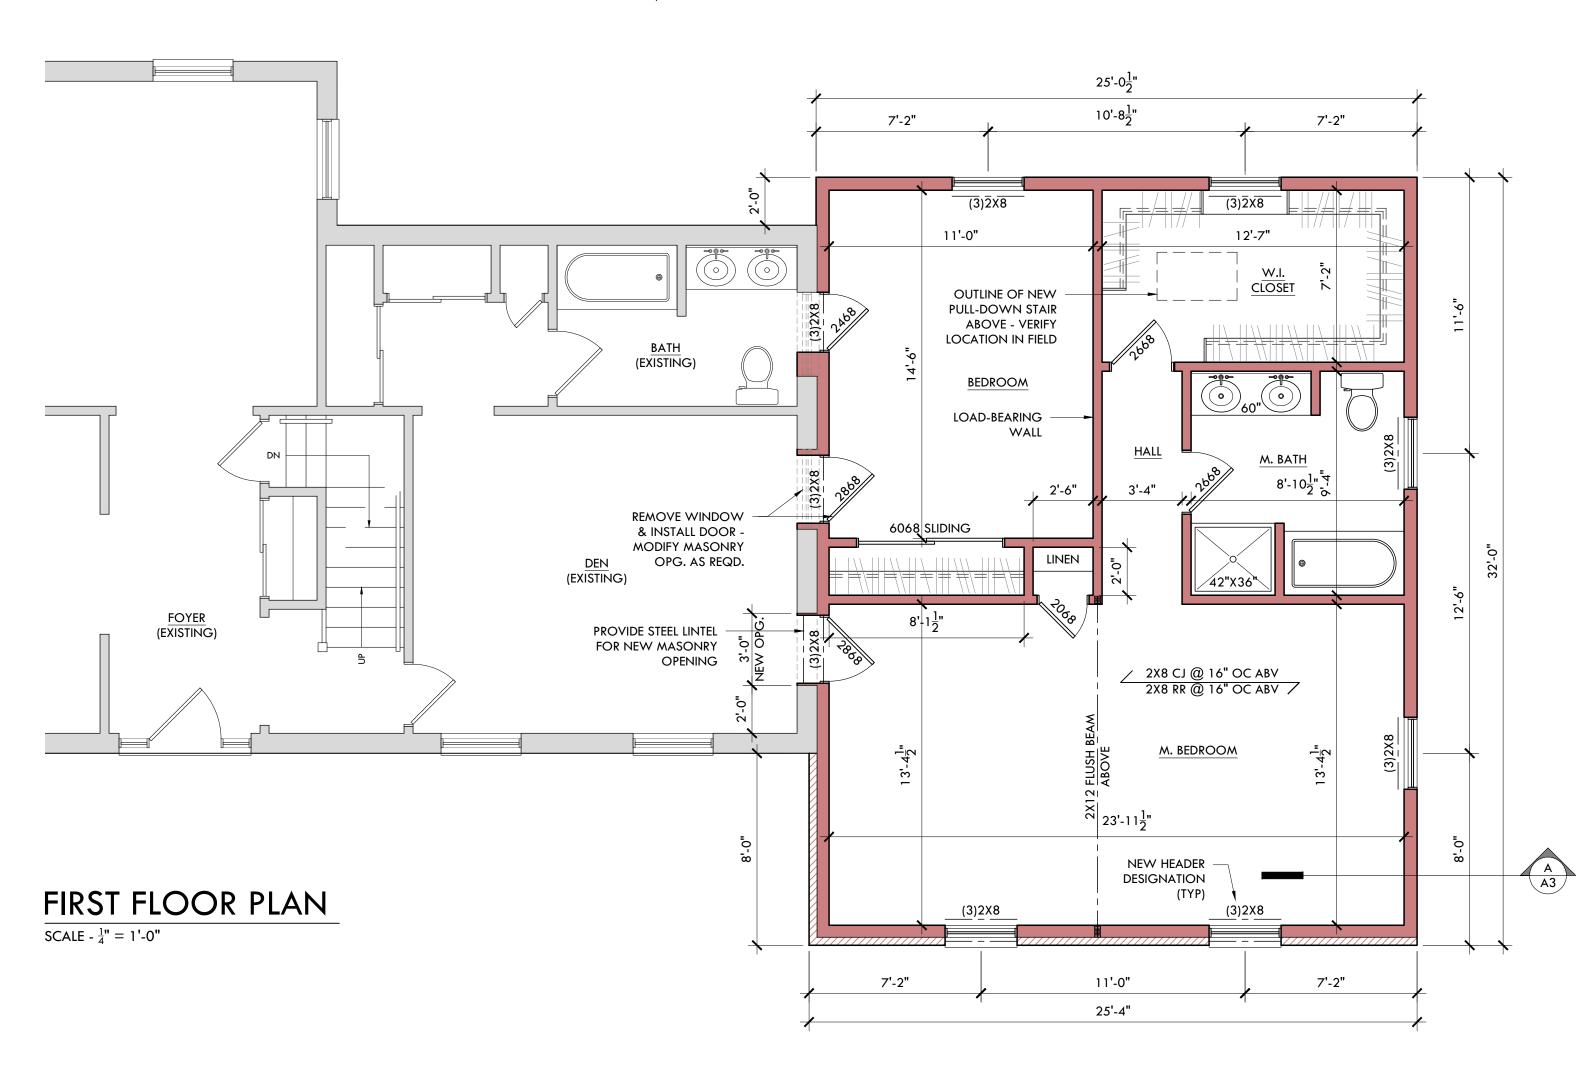


GENERAL NOTE:
THIS DOCUMENT IS FOR
GRAPHIC PURPOSES ONLY
CONSULTANT, DESIGNERS,
CONTRACTORS AND OTHER
TRADES SHALL BE
RESPONSIBLE FOR CHECKING
AND VERIFYING ALL PRESENT
AND EXISTING CONDITIONS,
DIMENSIONS, ETC. BEFORE
PROCEEDING WITH WORK

ODLARK CIRCLE

	DRAWN BY:	CHECKED BY:
	SCALE: AS NOTED	DATE: 6-30-25
	revisions:	

DO NOT SCALE DRAWINGS

SHEET 1 OF 3

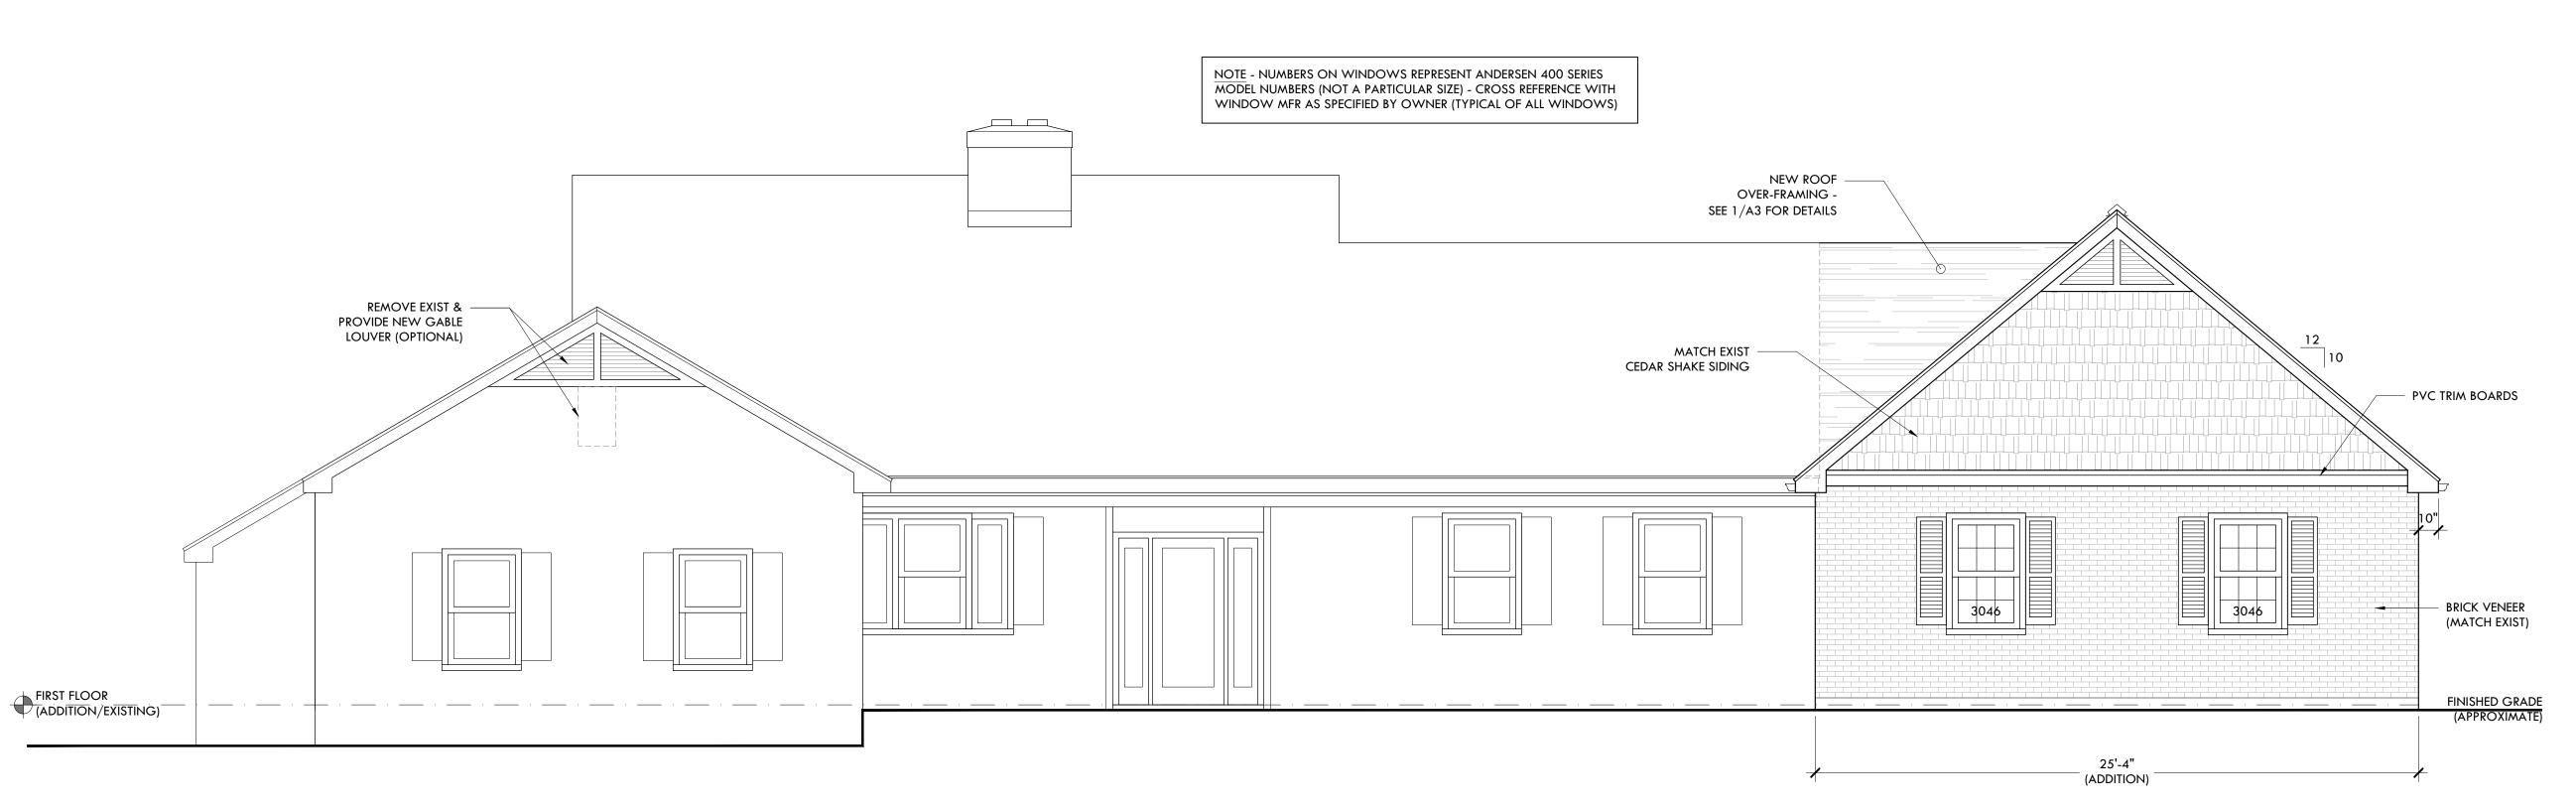


WEST/WOODLARK CIR ELEVATION SCALE - 1/4" = 1'-0"

NOTE - THE G.C. SHALL VERIFY THAT THE WINDOW USED FOR EGRESS MEETS THE FOLLOWING CRITERIA:


CLEAR OPENABLE AREA OF 5.7 SF

CLEAR OPENABLE WIDTH OF 20"

CLEAR OPENABLE HEIGHT OF 24"

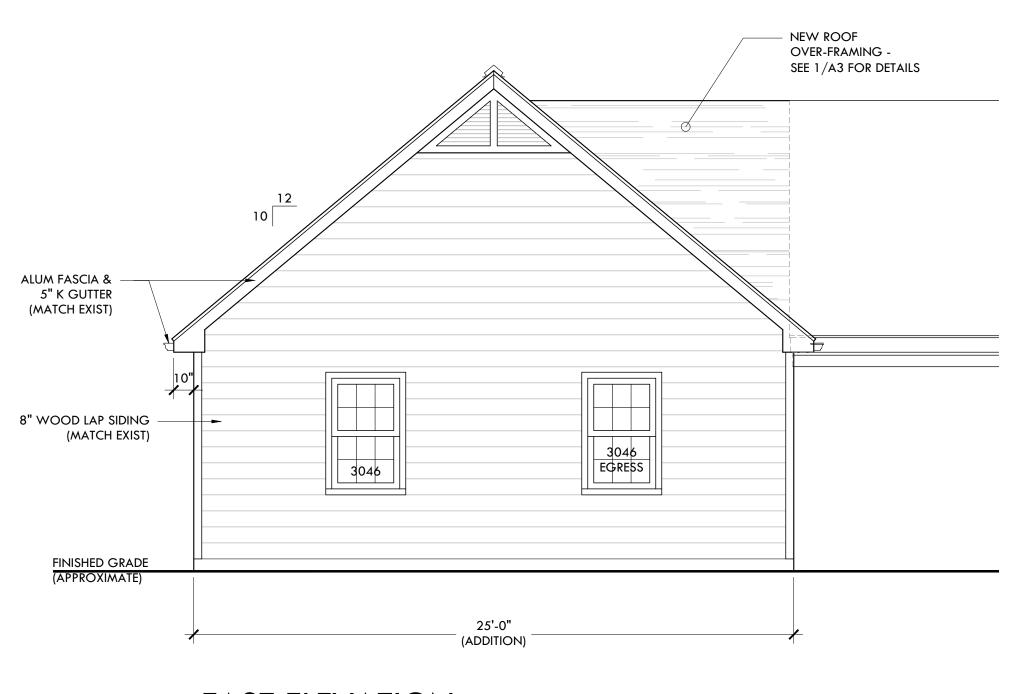



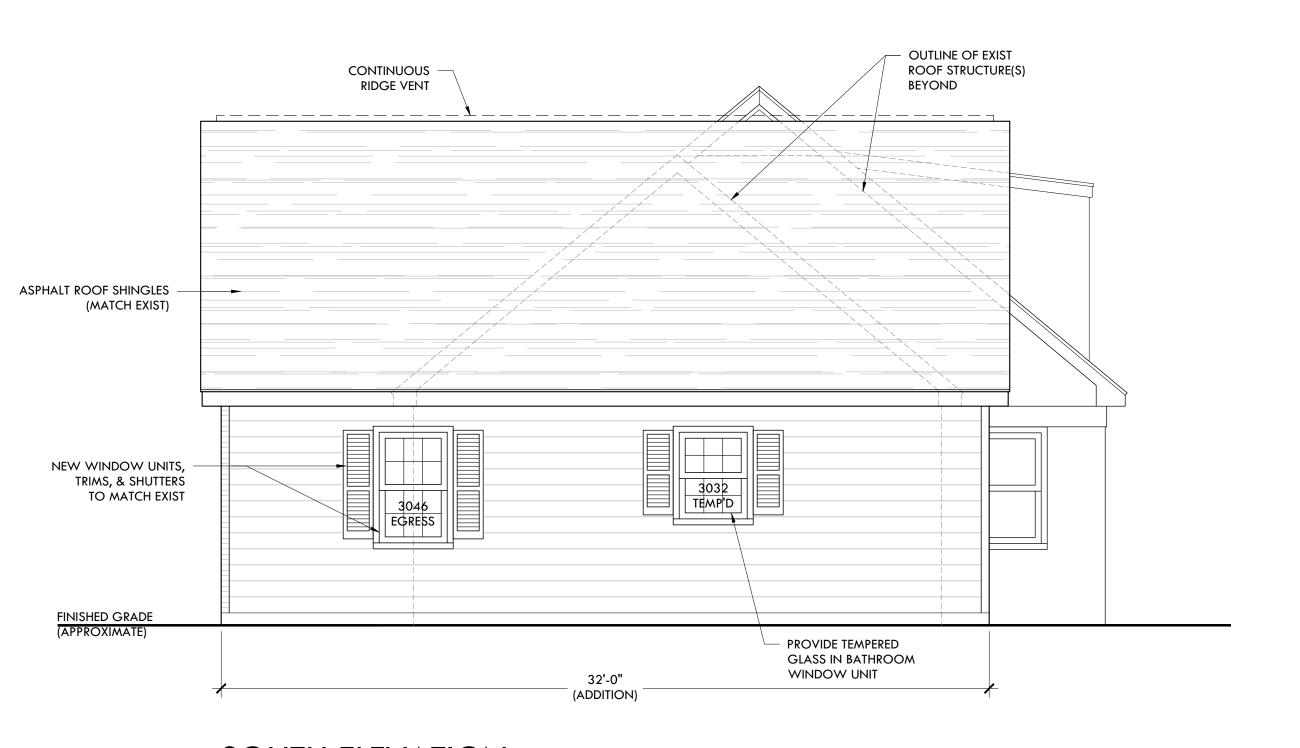

SOUTH ELEVATION

SCALE - 1/4" = 1'-0"

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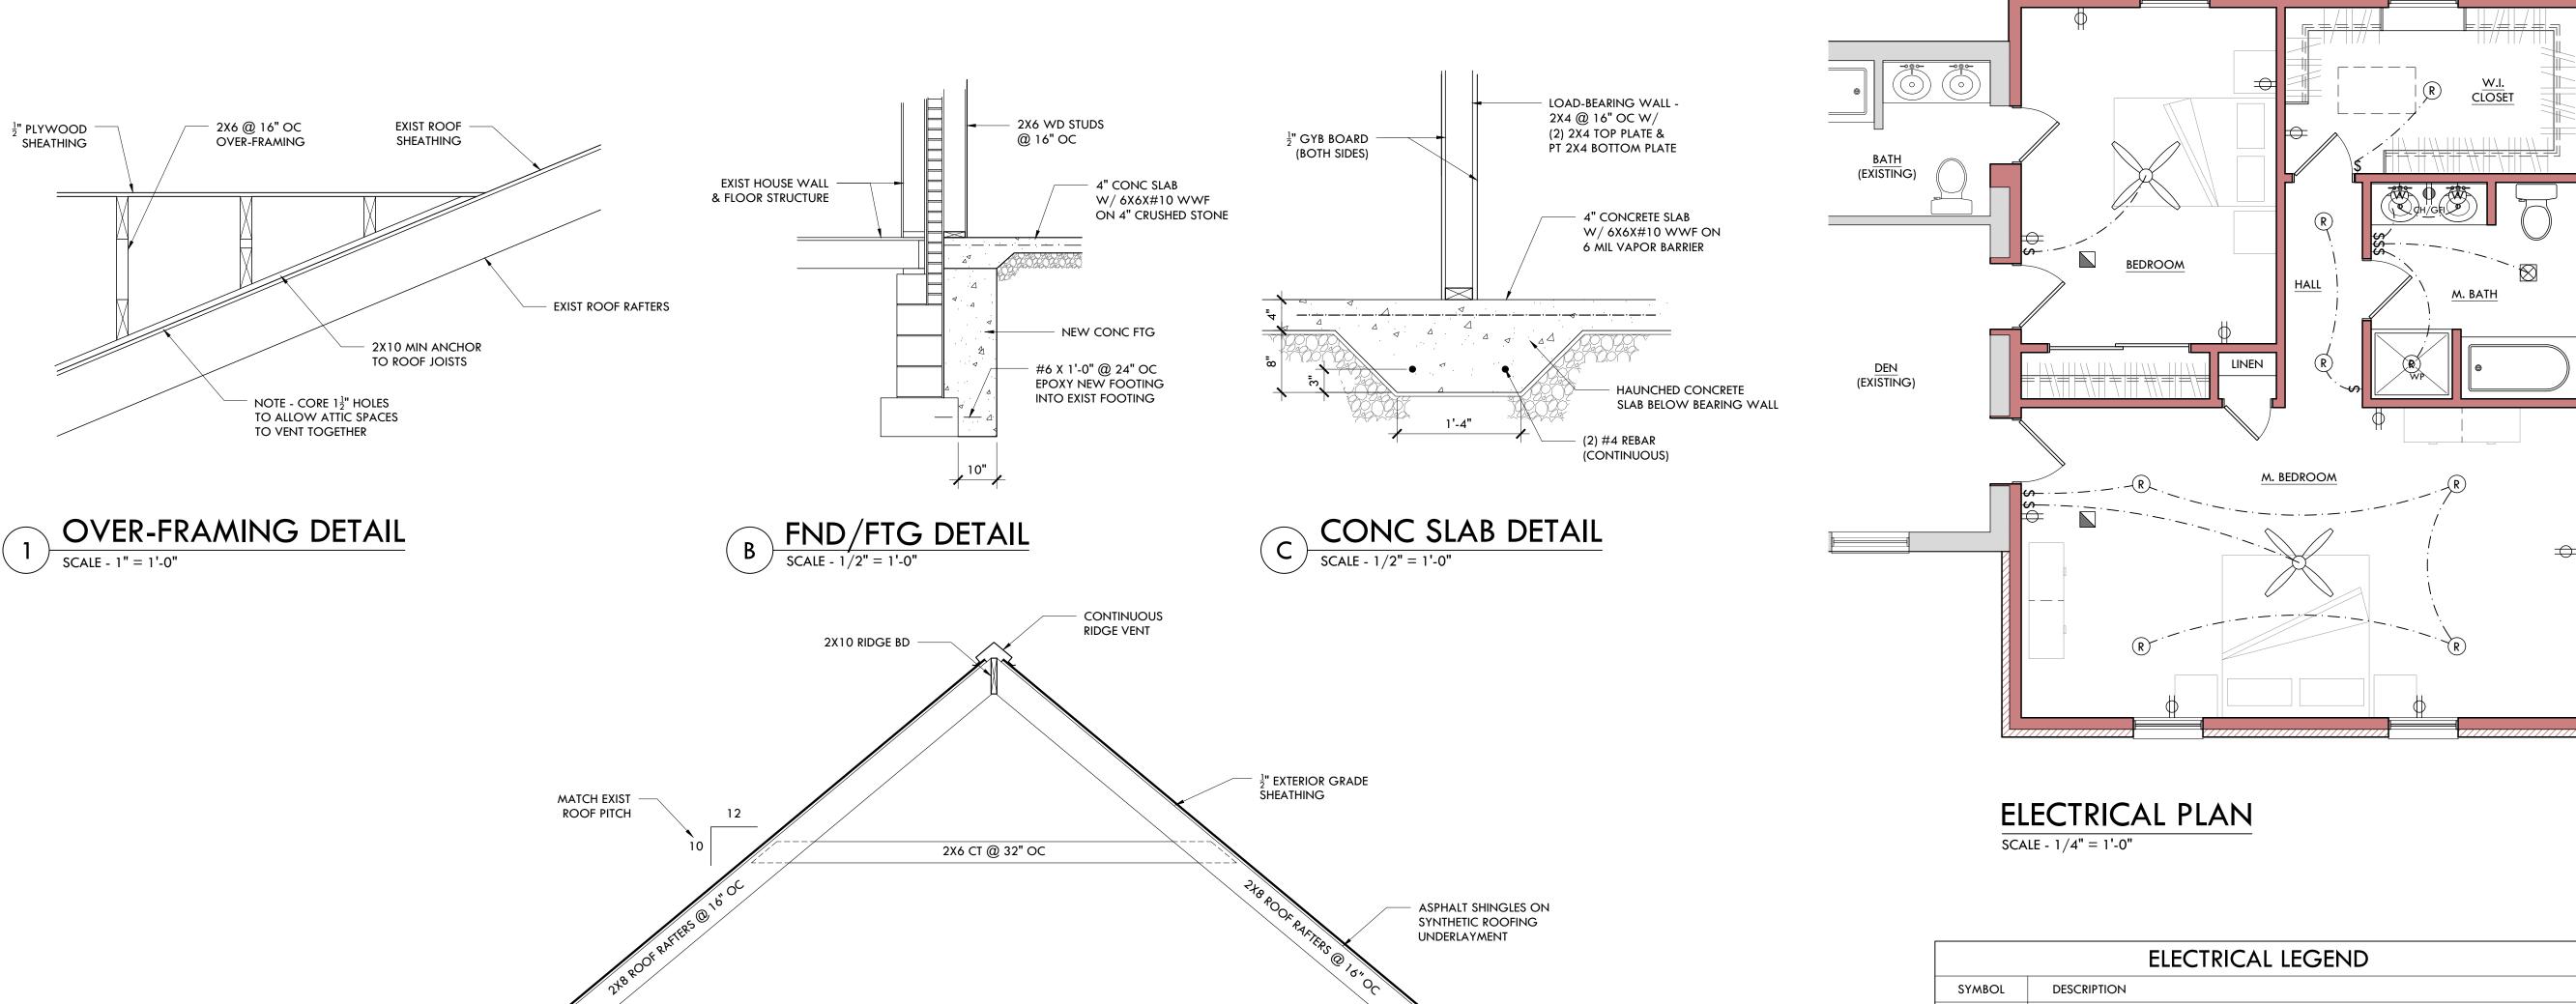
VOODLARK CIRCLE SIDENTIAL ADDITION

DRAWN BY:	CHECKED BY:
SCALE: AS NOTED	DATE: 6-30-25
REVISIONS:	

DO NOT SCALE DRAWINGS

A2

SHEET 2 OF 3



(2) 2X12 WOOD -

 $-\frac{1}{2}$ " Gyp board

2X8 CEILING JOISTS @ 16" OC

4" COMPACTED CRUSHED

STONE BASE

SIMPSON STRONG-TIE

2X8 CEILING JOISTS @ 16" OC

R-49 BATT INSULATION

W/ VAPOR BARRIER

JOIST HANGERS

M. BEDROOM

4" CONC SLAB

6 MIL VAPOR BARRIER

W/ 6X6X#10 WWF

- INSULATION BAFFLE

SIMPSON STRONG-TIE

H2.5A HURRICANE CLIP

@ EACH RAFTER/PLATE CONNECTION (TYP)

5" ALUM K GUTTER

ON ALUM FASCIA

DEPTH & TRIMS

TYVEK HOUSE WRAP

SHEATHING

WOOD SIDING

(MATCH EXIST)

ON $\frac{1}{2}$ " EXTERIOR GRADE

FIN GRADE

- 8" CONC FND WALL

SOFFIT (33% VENTED)

MATCH EXIST OVERHANG

(TYP)

2X6 WD STUDS

 $\frac{1}{2}$ " GYPSUM BOARD

R-10 RIGID INSULATION

(2) #4 REBAR CONT -

(24" HORIZONTAL & VERTICAL)

CONT CONC FOOTING

@ 16" OC


CONT 2X6 PT

RIGID INSULATION

AS BOND BREAK

SILL PLATE

MATERIAL

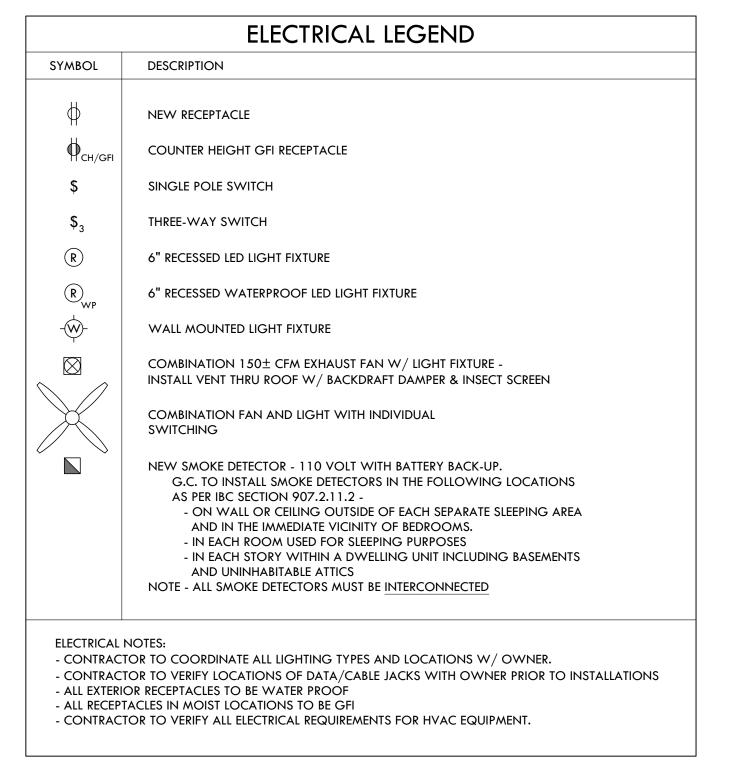

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CIR Δ

	DRAWN BY:	CHECKED BY:
	SCALE: AS NOTED	DATE: 6-30-25
	REVISIONS:	

DO NOT SCALE DRAWINGS

SHEET 3 OF 3

2'-0"

EXIST MAIN ROOF

TOP OF PLATE (ADDITION)

FIRST FLOOR
(EXIST/ADDITION)

EAVE

====

BRICK VENEER W/

GALV TIES @

ADJUST PLATE HEIGHT

TO MATCH EXIST

OVERHANG LEVEL

ALUM FLASHING

W/ WEEP HOLES

24" (VERT)

32" OC (HORIZ)

L ALIGN -

(2)2X6 PLATE

- R-21 BATT INSULATION

 $-\frac{1}{2}$ "X12" (W/HOOK) ANCHOR BOLTS

CONT CONC FOOTING

- (3) #4 REBAR CONT

@ 48" OC (12" MAX FROM

10" CONC FND WALL

EA CORNER)

W/ VAPOR BARRIER