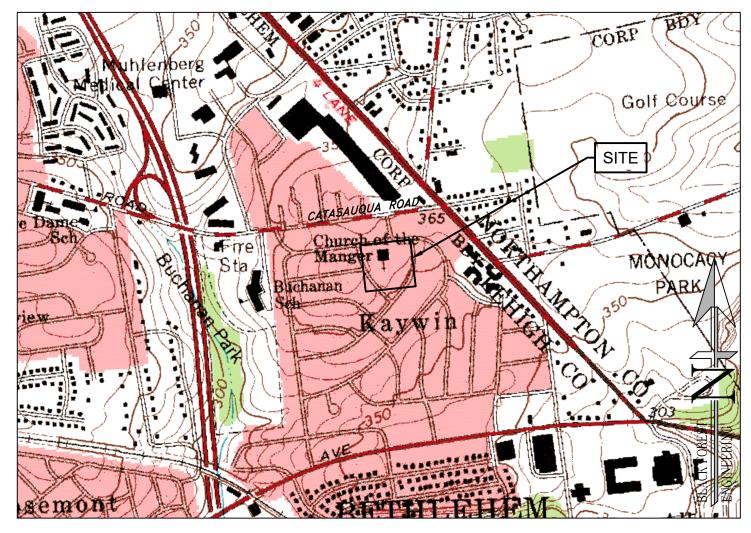
LAND DEVELOPMENT LOCATED IN THE
CITY OF BETHLEHEM
WARD 13 BLOCK 113
LEHIGH COUNTY
COMMONWEALTH OF PENNSYLVANIA

INVOLVING PARCELS LOCATED AT 1411 GREENVIEW DRIVE

# 1411 GREENVIEW DRIVE LAND DEVELOPMENT

PRELIMINARY/FINAL PLAN





LOCATION MAP

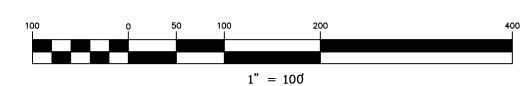
USGS CATASAUQUA QUADRANGLE
SCALE: 1"=1000'

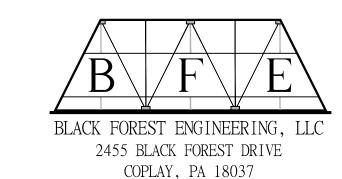
FINAL PLAN SHEET INDEX PLAN TITLE SHEET NO. COVER \* RECORD PLAN EXISTING FEATURES PLAN UTILITY PLAN GRADING PLAN LANDSCAPE AND LIGHTING PLAN CONSTRUCTION DETAILS CONSTRUCTION DETAILS |PRE-DEV DRAINAGE PLAN POST-DEV DRAINAGE PLAN SUPPLEMENTAL PLANS ESPC PLAN PCSM PLAN \* DENOTES PLAN TO BE RECORDED

PLAN INTENT

THE APPLICANT WISHES TO CONSTRUCT 24 TOWNHOMES WITH OFFSTREET PARKING, STORMWATER MANAGEMENT, LANDSCAPING AND PUBLIC UTILITIES.

EQUITABLE OWNER / DEVELOPER: 1015 PARTNERS LLC 555 ASHWOOD ROAD NAZARETH, PA 18064





\*\*CALL BEFORE YOU DIG\*\*


PENNSYLVANIA LAW REQUIRES 3 WORKING DAYS NOTICE FOR CONSTRUCTION PHASE AND 10 WORKING DAYS IN DESIGN STAGE — STOP CALL

PENNSYLVANIA ONE CALL SYSTEM, INC.

1-800-242-1776

SERIAL NO.20232380206

REV:	DES	CRIPTION:		BY	DATE
PROJECT	NO.	SCALE:	DATE:	REVIS	SION:
23	30		9/5/23		O

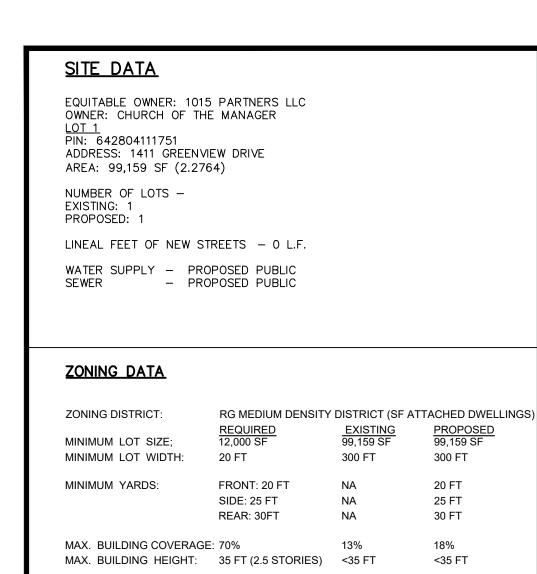

SURVEY NOTES:

MIN. LOT AREA PER

DWELLING UNIT:

. THIS PLAN IS BASED ON A FIELD SURVEY CONDUCTED MAY 23, 2023 BY BLACK FOREST ENGINEERING LLC USING A TOTAL

4,131 SF

STATION AND GPS RTK UNIT.

2. BEARINGS BASED ON PA STATE PLANE SOUTH, NAD83.


4,000 SF


- 3. ELEVATIONS BASED ON NAVD88.
  4. UTILITY LOCATIONS SHOULD BE CONSIDERED APPROXIMATE AND HAVE BEEN BASED ON VISIBLE ABOVE—GROUND EVIDENCE. A CONTRACTOR SHALL DETERMINE THE ACTUAL LOCATION OF ALL UTILITIES SHOWN ON THIS PLAN AND ANY ADDITIONAL EXISTING UTILITIES NOT SHOWN ON THIS PLAN.
- 5. BOUNDARY LINES SHOWN WITH BEARINGS AND DISTANCES OR CURVE INFORMATION HAVE BEEN FIELD VERIFIED BY THIS SURVEY.


#### BENCHMARK FOR THIS PLAN

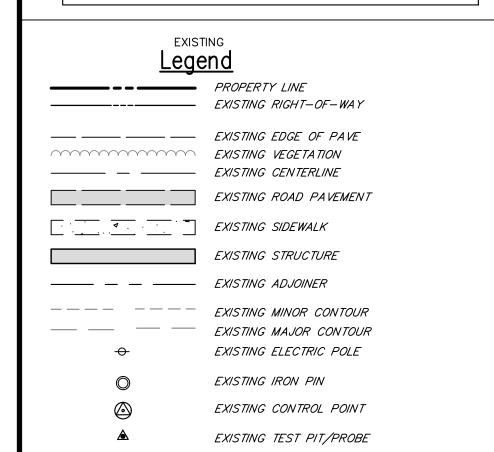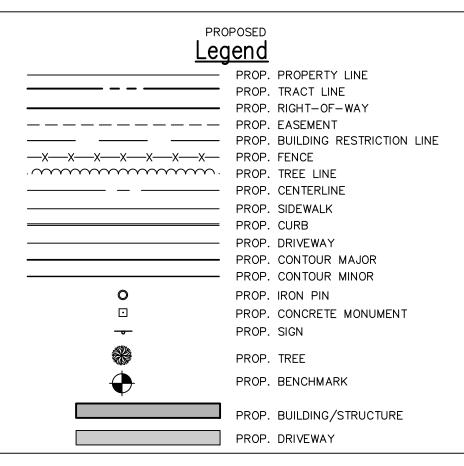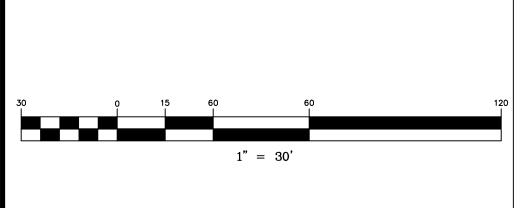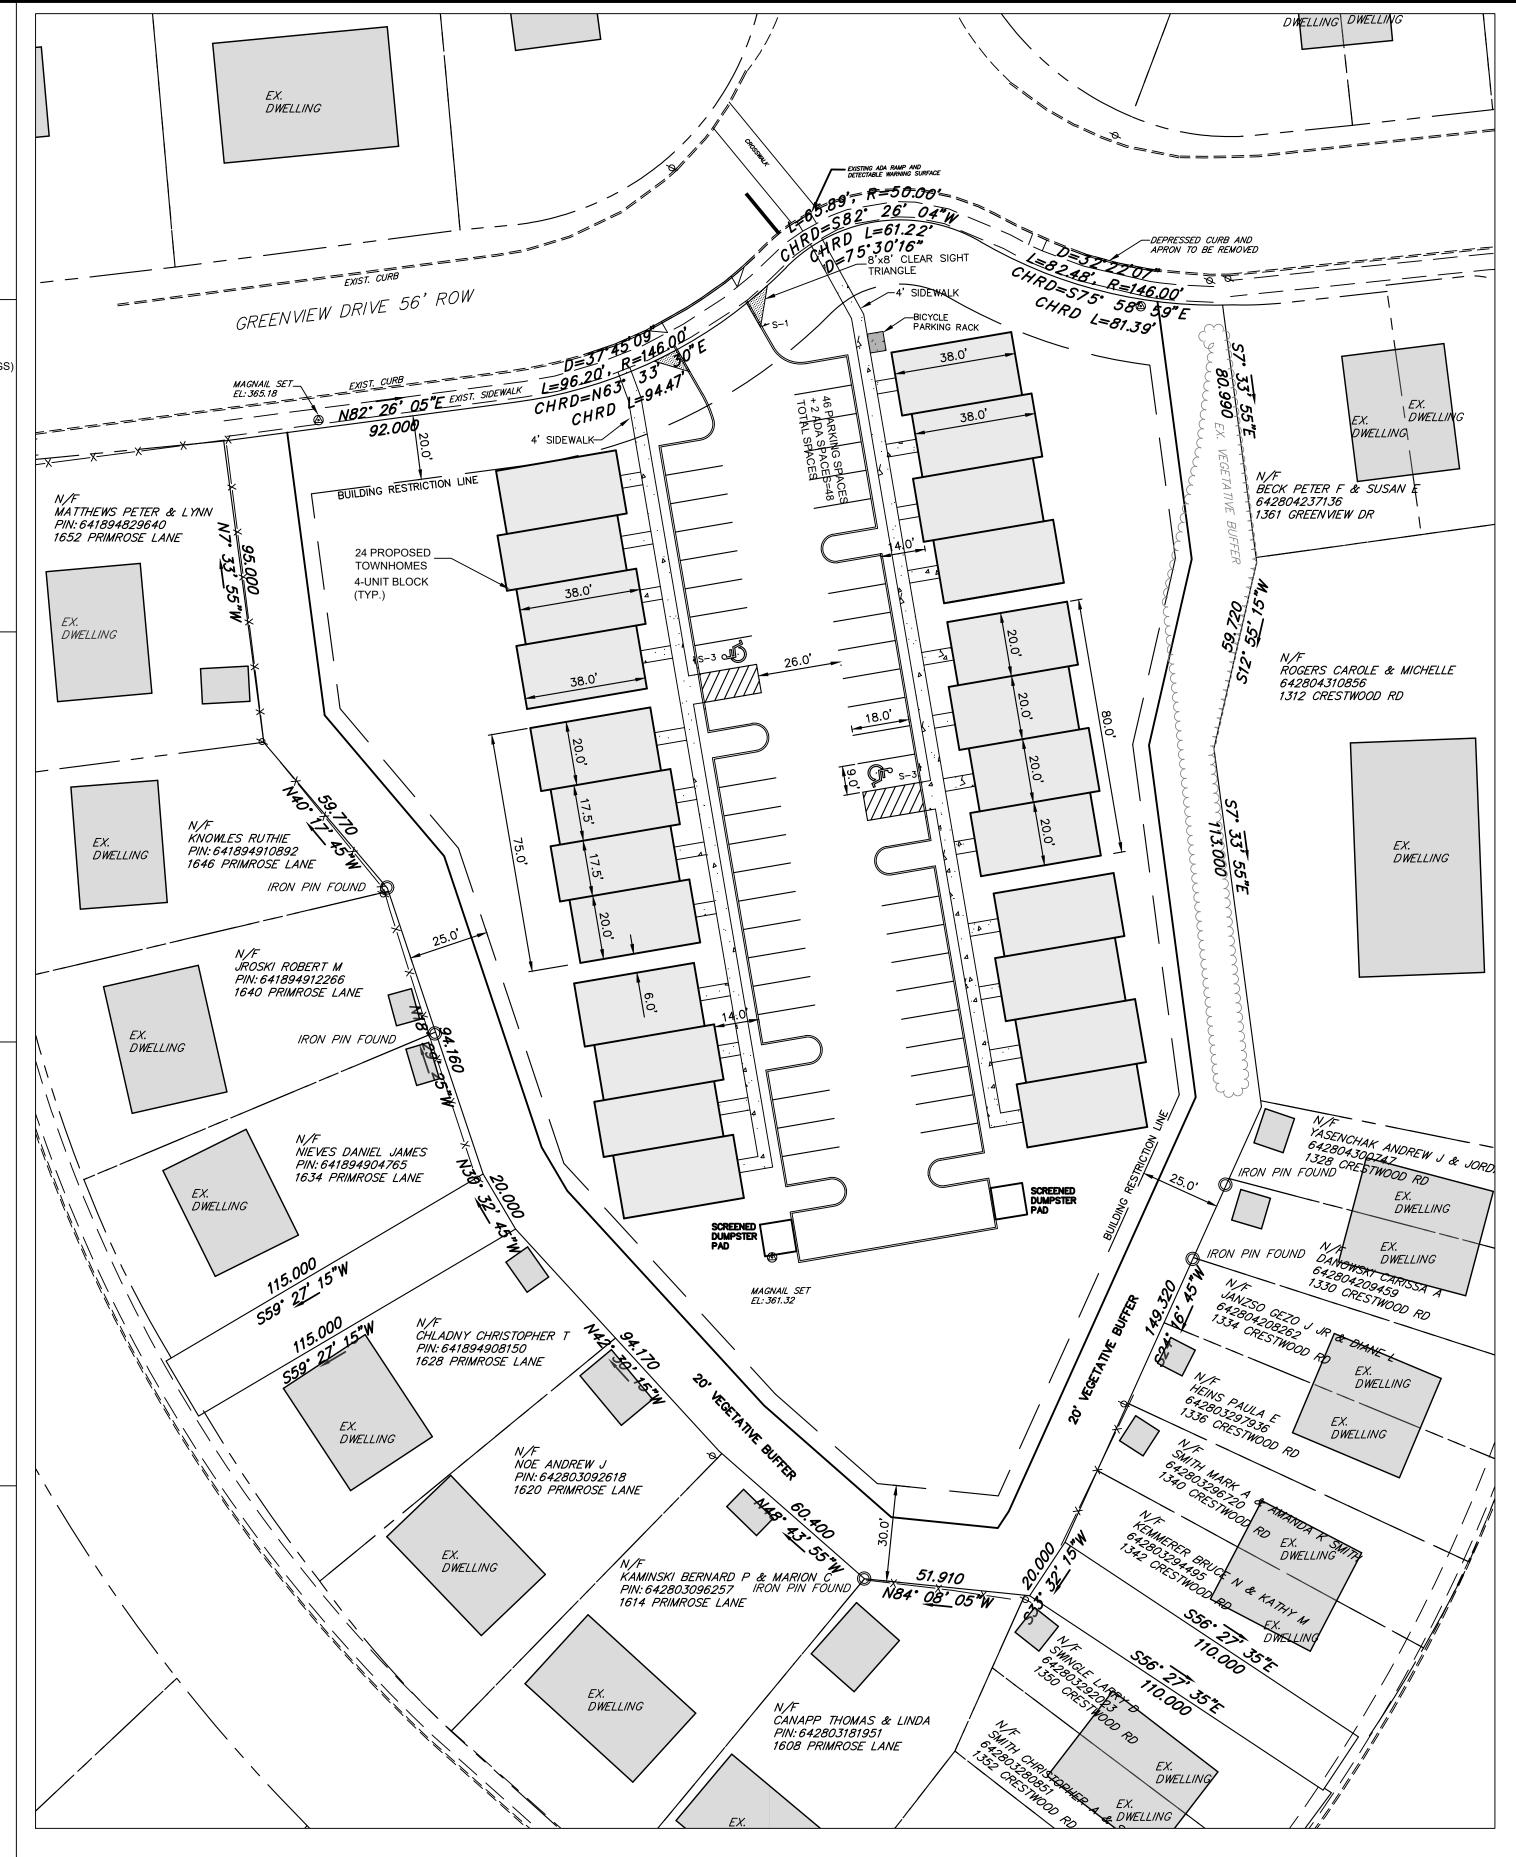
VERTICAL CONTROL IS BASED UPON THE NORTH AMERICAN VERTICAL DATUM OF 1988 (NAVD 88). BEARING SYSTEM BASED UPON THE PENNSYLVANIA NORTH AMERICAN DATUM OF 1983, SOUTH ZONE, US FOOT (PA-NAD83).

1. EXISTING MAGNAIL ELEV.=365.18









#### PARKING REQUIREMENT

VEHICLE:
2 SPACES PER DWELLING
24 UNITS x 2 = 48 SPACES REQ'D (48 PROVIDED)

IMPERVIOUS COVER

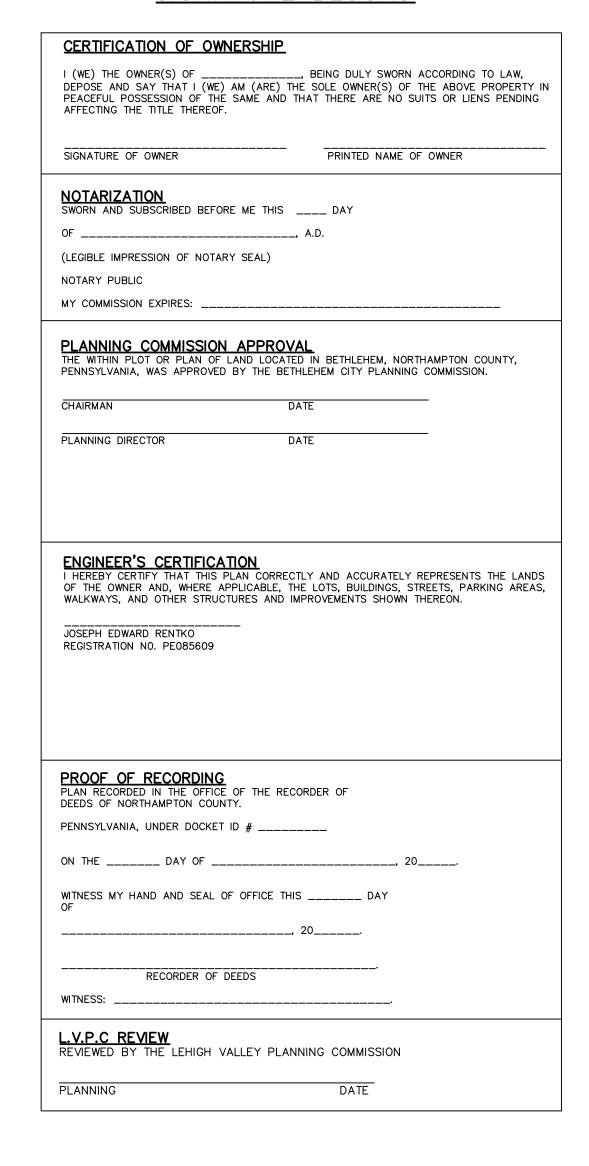
EXISTING CONDITION=30,210 SF

PROPOSED CONDITION=38,000 SF

NOTE: AN INCREASE OF 7,790 SF IS PROPOSED AND THEREFOR ACT 167 APPROVAL IS NOT REQUIRED. STORMWATER WILL BE CONTROLLED UNDER NPDES REGULATORY REQUIREMENTS.

	SIGN SCHEDULE									
SYMBOL	LEGEND	QTY.	BLANK SIZE	PENNDOT #						
S-1	STOP	1	24 X 24	R1-1						
S-2	RESERVED PARKING 🖒 WITH PARKING FINE PLAQUE	0	12 X 18 12 X 18	R7-8 R7-8B						
S-3	SAME AS S-2 WITH VAN ACCESSIBLE PLAQUE AND PARKING FINE PLAQUE	2	12 X 18 12 X 6 12 X 18	R7-8 R7-8A R7-8B						

#### SIGNATURE BLOCKS



#### RECORD NOTES

- . EACH LOT SHOWN IS SUBJECT TO ALL EASEMENTS VISIBLE, OR ON RECORD, OR AS REQUIRED BY A UTILITY TO SERVE SAID LOT AT SUCH TIME AS THE UTILITY IS INSTALLED.
- 2. ALL IMPROVEMENTS WITHIN THE PUBLIC RIGHT-OF-WAY SHALL COMPLY WITH THE CITY OF BETHLEHEM STANDARDS AND SPECIFICATIONS
- AND THE APPROPRIATE PUBLIC UTILITY AUTHORITIES.

  3. THE SITE WAS EVALUATED FOR WETLANDS AND WATERCOURSES AND IT WAS DETERMINED THAT WETLANDS AND WATERCOURSES DO NOT
- EXIST ON THE SITE.

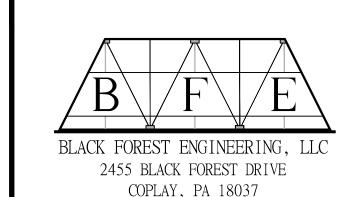
  4. THERE ARE NO FEMA DELINEATED 100-YR FLOODPLAINS OR WATERCOURSES ON OR NEAR THIS PROPERTY.
- 5. ALL LOTS SHALL HAVE A FIVE (5) FOOT DRAINAGE, GRADING AND UTILITY EASEMENT ALONG OUTER LOT LINES UNLESS NOTED OTHERWISE.
- 6. ACTUAL UTILITY CONNECTION POINTS SHALL BE VERIFIED PRIOR TO CONSTRUCTION.
- ALL LOTS SHALL BE LAID OUT AND GRADED TO PREVENT CROSS LOT DRAINAGE AND TO PROVIDE POSITIVE DRAINAGE AWAY FROM PROPOSED BUILDING AREAS.
- 8. ALL CITY PERMITS MUST BE OBTAINED PRIOR TO THE START OF CONSTRUCTION.
- RUNOFF FROM ALL ON-SITE IMPERVIOUS AREAS SHALL NOT BE DIRECTED INTO THE PUBLIC SANITARY SEWER, ACROSS THE SIDEWALK AREA WITHIN THE PUBLIC RIGHT-OF-WAY, OR ONTO ADJOINING PROPERTIES, SECTION 1753.08 B.4 OF THE CITY PROPERTY REHABILITATION & MAINTENANCE CODE.
- 10. ALL LATERAL SANITARY SEWER PIPING IS TO BE SCH 40 OR SDR-26 PVC PIPING UNLESS OTHERWISE NOTED..
- 11. WORK TO BE PERFORMED ONSITE, SHALL BE DONE IN ACCORDANCE WITH THE IBC.
- 12. ANY RETAINING WALL 4 FEET OR GREATER IN HEIGHT SHALL HAVE A DESIGN PREPARED, SIGNED, AND SEALED BY A PROFESSIONAL ENGINEER REGISTERED IN THE STATE OF PENNSYLVANIA AND SHALL BE SUBMITTED AT THE TIME OF BUILDING PERMIT APPLICATION TO BE REVIEWED AND APPROVED BY AN APPROVED THIRD PARTY REVIEWER. THE WALL SHALL BE DESIGNED TO BE CONTAINED COMPLETELY WITHIN THE APPLICANT'S PROPERTY OR AN EASEMENT SHALL BE ACQUIRED AND INDICATED ON THE RECORD PLAN TO ALLOW FOR THE CONSTRUCTION OF ANY PORTION OF THE WALL AND/OR WALL TIE BACKS TO BE CONSTRUCTED ON THE ADJOINING PROPERTY.
- 13. ALL PAVEMENT MARKINGS MUST BE THERMOPLASTIC PAVEMENT MARKINGS.
- 14. THE PROJECT WILL REQUIRE AN APPROVED PLANNING MODULE FOR 24-UNITS, SEE DEP CODE# (xxxxxxxxxx).
- 15. A TOTAL LOT (BLANKET) STORMWATER MANAGEMENT EASEMENT IS HEREBY PROVIDED ACROSS THE LOT IN ORDER FOR INSPECTION AND MAINTENANCE OF THE PROPOSED STORMWATER MANAGEMENT CONTROLS.
- 16. THE CITY OF BETHLEHEM FIRE DEPARTMENT SHALL APPROVE THE FINAL LOCATION OF THE PROPOSED FIRE HYDRANT. THE PROPOSED UNITS WILL BE INDIVIDUALLY SPRINKLERED AND THEREFORE A KNOX BOX, FIRE DEPARTMENT CONNECTION (FDC), AND POST INDICATING VALVE (PIV) HAVE NOT BEEN PROPOSED.
- 17. BY SUBMISSION OF THESE PLANS THE ENGINEER ON RECORD CERTIFIES THAT THESE PLANS ARE IN COMPLETE CONFORMANCE WITH THE CITY OF BETHLEHEM STORMWATER MANAGEMENT ORDINANCE.
- 18. IN ORDER TO MAINTAIN CONTINUITY BETWEEN PLAN REVISIONS, ANY CHANGES TO A PREVIOUS PLAN SUBMISSION SHALL BE FLAGGED WITH A TRIANGLE. ANY CHANGES NOT FLAGGED MAY BE CONSIDERED NOT APPROVED. FLAGGED CHANGES SHALL BE REFERENCED TO THE APPROPRIATE REVISION DATE DATE IN THE REVISION BLOCK.
- 19. ACCURATE AS-BUILT PLANS SHALL BE KEPT UP TO DATE DURING THE CONSTRUCTION PROCESS. AT THE COMPLETION OF THE PROJECT RECORD DRAWINGS SHALL BE DEVELOPED FROM THE AS-BUILT PLANS AND SUBMITTED TO THE CITY ENGINEER'S OFFICE. ALL FINAL DRAWINGS SHALL SHOW NORTH AMERICAN DATUM (NAD) 1983 STATE PLANE COORDINATES IN FEET (PA SOUTH, FIPS ZONE 3702) AND THE DIGITAL FILE SHALL BE IN STATE PLANE FEET COORDINATES AS APPLICABLE. THE HARD COPY OF THE RECORD DRAWINGS SHALL BE IN THE FORM OF MYLAR COPY. THE ENGINEER OF RECORD SHALL CERTIFY (IE PE STAMPED AND SIGNED) THAT THE RECORD DRAWINGS COMPLY SUBSTANTIALLY WITH THE APPROVED PLAN AND THAT THEY CONFORM TO INDUSTRY STANDARDS. ALL DIGITAL FILES RESIDE ON PC COMPATIBLE CD ROM CONTAINING THE DIGITAL REPRESENTATION OF THE FINAL PLANAS PRESENTED ON THE TWENTY—FOUR (24) INCH BY THIRTY—SIX (36) INCH SHEETS. THE DIGITAL MAP SHALL BE AUTOCAD COMPATIBLE. ALL LAYERS INCLUDED IN THE DIGITAL MAPS SHALL BE THE STANDARDIZED LAYERS PREPARED AND UTILIZED BY THE CITY OF BETHLEHEM TO ENSURE COMPATIBLITY WITH THE CITY'S EXISTING CAD STANDARDS AND AS DESCRIBED IN THE APPENDIX A OF THE CITY'S SUBDIVISION AND LAND DEVELOPMENT ORDINANCE.

PENNSYLVANIA LAW REQUIRES 3 WORKING DAYS NOTICE FOR CONSTRUCTION PHASE AND 10 WORKING DAYS IN DESIGN STAGE - STOP CALL


PENNSYLVANIA ONE CALL SYSTEM, INC.

1-800-242-1776

SERIAL NO.20232380206



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EV:	DESCRIPTION:	BY	DATE
ROJEC	T TITLE:		

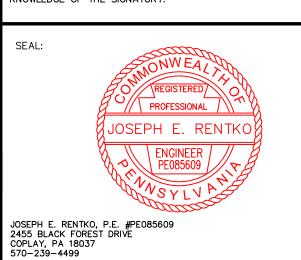1411 GREENVIEW DRIVE

TABLE OWNER:

1015 PARTNERS LLC 555 ASHWOOD ROAD NAZARETH, PA 18064

CITY OF BETHLEHEM
WARD 13; BLOCK 113
LEHIGH COUNTY
PENNSYLVANIA

PLAN TITLE:	RECORD								
SCALE: 1"=30'	DATE: 9/5/23	DRAWN: JER	CHECKED: JER						
PROJECT NO.	DRAWII	NG NO.	REVISION:						

### DWELLING **DWELLING** \_\_\_DEPRESSED CURB AND APRON TO BE REMOVED DWELLING N/F BECK PETER F & SUSAN E 642804237136 1361 GREENVIEW DR MATTHEWS PETER & LYNN PIN: 641894829640 1652 PRIMROSE LANE EX. DWELLING ROGERS CAROLE & MICHELLE 642804310856 1312 CRESTWOOD RD EXIST. PAVE EX. BUILDING KNOWLES RUTHIE PIN: 641894910892 1646 PRIMROSE LANE EX. DWELLING DWELLING JROSKI ROBERT M PIN: 641894912266 1640 PRIMROSE LANE IRON PIN FOUND **DWELLING** IRON PIN FOUND CRESTWOOD RD NIEVES DANIEL JAMES PIN: 641894904765 1634 PRIMROSE LANE EXIST. PAVE EX. DWELLING ~~~ CHLADNY CHRISTOPHER T PIN: 641894908150 1628 PRIMROSE LANE EX. DWELLING EX. DWELLING EX. DWELLING WOE ANDREW J PIN: 642803092618 1620 PRIMROSE LANE EX. DWELLING KAMINSKI BERNARD P & MARION C 51.910 PIN: 642803096257 IRON PIN FOUND N84° 08' 05'W 1614 PRIMROSE LANE DWELLING CANAPP THOMAS & LINDA PIN: 642803181951 1608 PRIMROSE LANE DWELLING EX. DWELLING

BUILDING RESTRICTION LINE
EXISTING EDGE OF PAVE

EXISTING VEGETATION

———— — EXISTING CENTERLINE

EXISTING SIDEWALK

——— — EXISTING ADJOINER

EXISTING STORM SEWER

——————— EXISTING MINOR CONTOUR

----- EXISTING WATER LINE

---- EXISTING CURB

EXISTING ROAD PAVEMENT

EXISTING STRUCTURE

EXISTING MAJOR CONTOUR
EXISTING ELECTRIC POLE

EXISTING GAS VALVE

EXISTING WATER VALVE

EXISTING FIRE HYDRANT

EXISTING CONTROL POINT

EXISTING TEST PIT/PROBE

EXISTING IRON PIN

EXISTING INLET

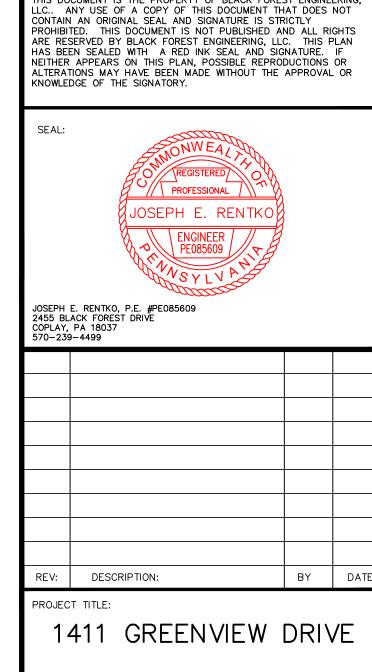
EXISTING GAS LINE
EXISTING SANITARY LINE

SOIL TYPES

UmB Urban land—Duffield Complex, 0 to 8 percent slopes

#### **EXISTING TREES:**

THERE ARE NO EXISTING TREES MEETING THE REQUIREMENTS OF CITY ORDINANCE 1318.28 PLANNED FOR REMOVAL. ANY SUCH EXISTING TREE MEETING THIS REQUIREMENT SHALL BE REPLACED AS REQUIRED.



BLACK FOREST ENGINEERING, LLC

2455 BLACK FOREST DRIVE

COPLAY, PA 18037

THIS DOCUMENT IS THE PROPERTY OF BLACK FOREST ENGINEERING,

30 0 15 60 60 1" = 30' LEHIGH COUNTY
PENNSYLVANIA

N TITLE:
FYICTING SITE


1015 PARTNERS LLC 555 ASHWOOD ROAD NAZARETH, PA 18064


CITY OF BETHLEHEM WARD 13; BLOCK 113

PROJECT OWNER:


PROJECT LOCATION:

	•		
SCALE: 1"=30'	DATE: 9/5/23	DRAWN: JER	CHECKED: JER
project no. 2209	7	NG NO. F 9	REVISION:

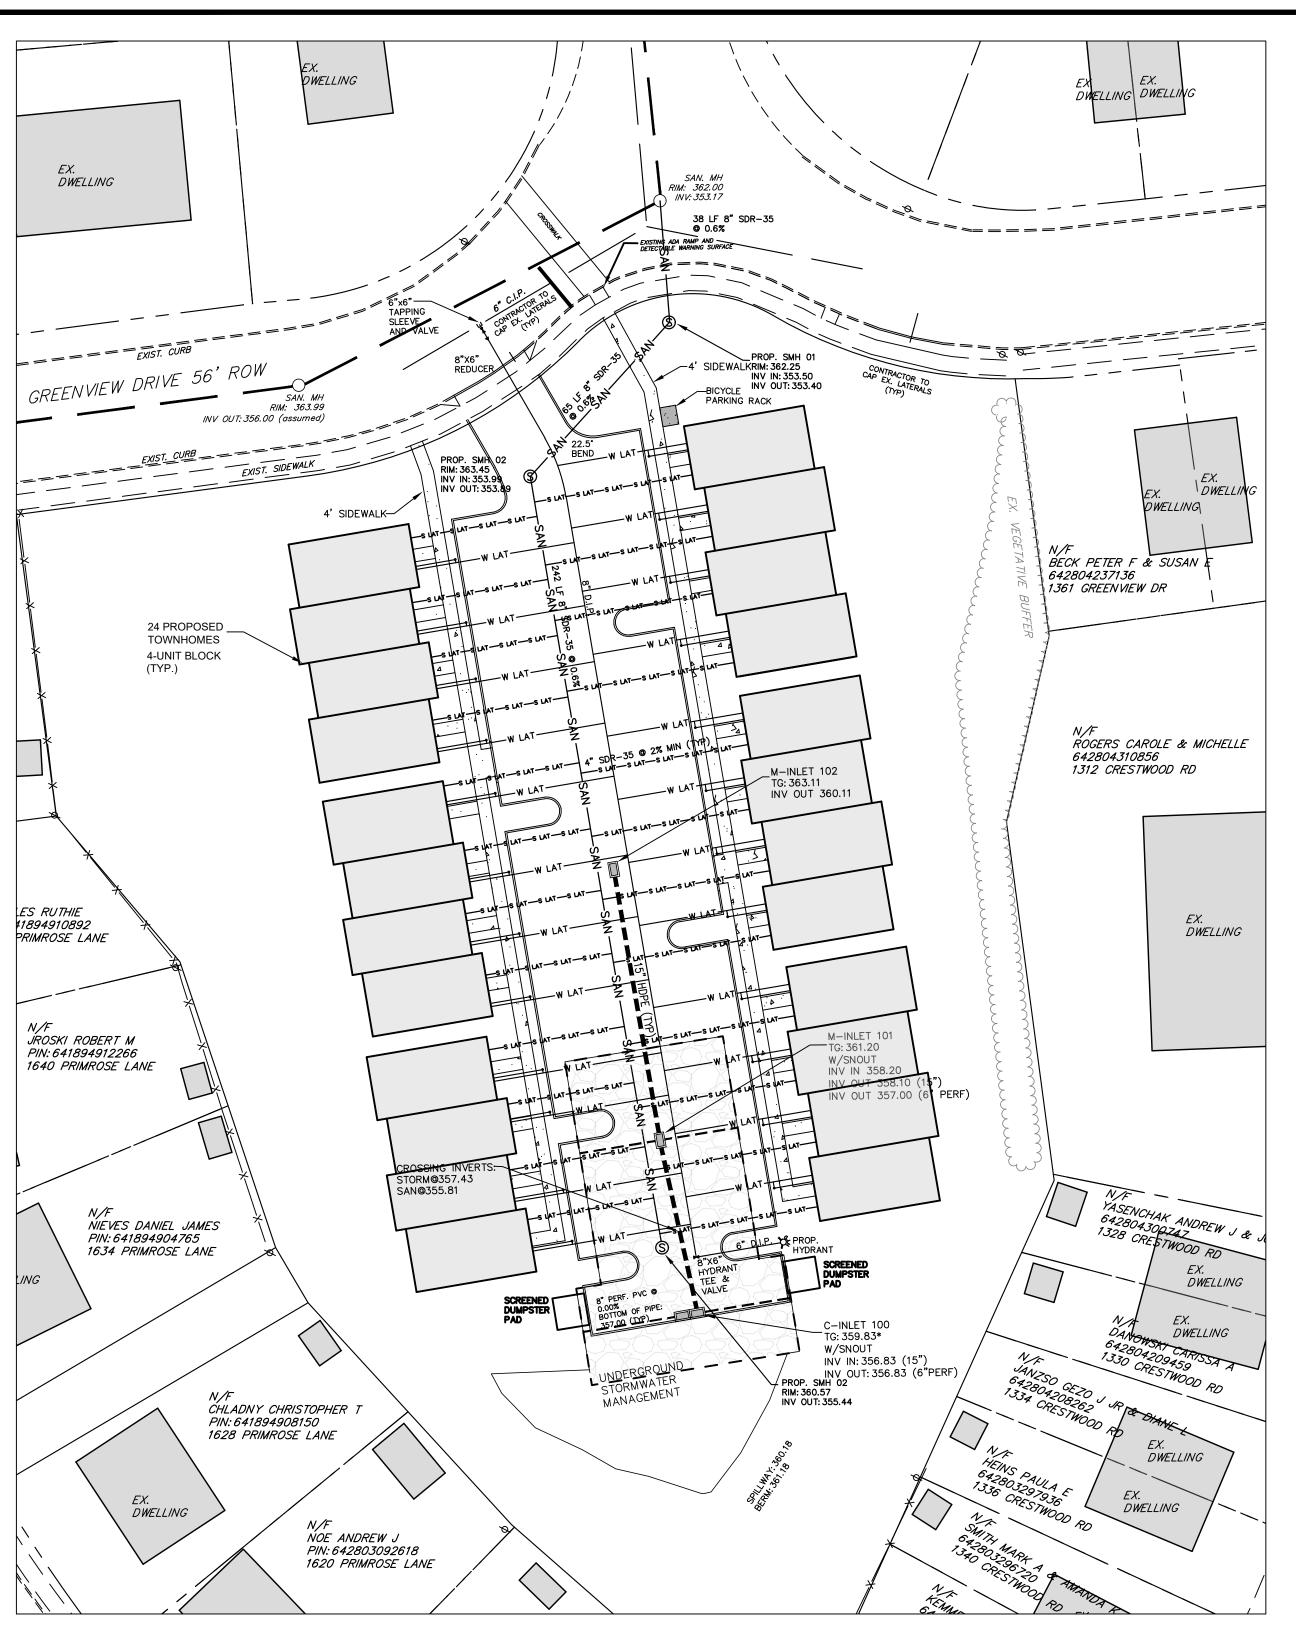

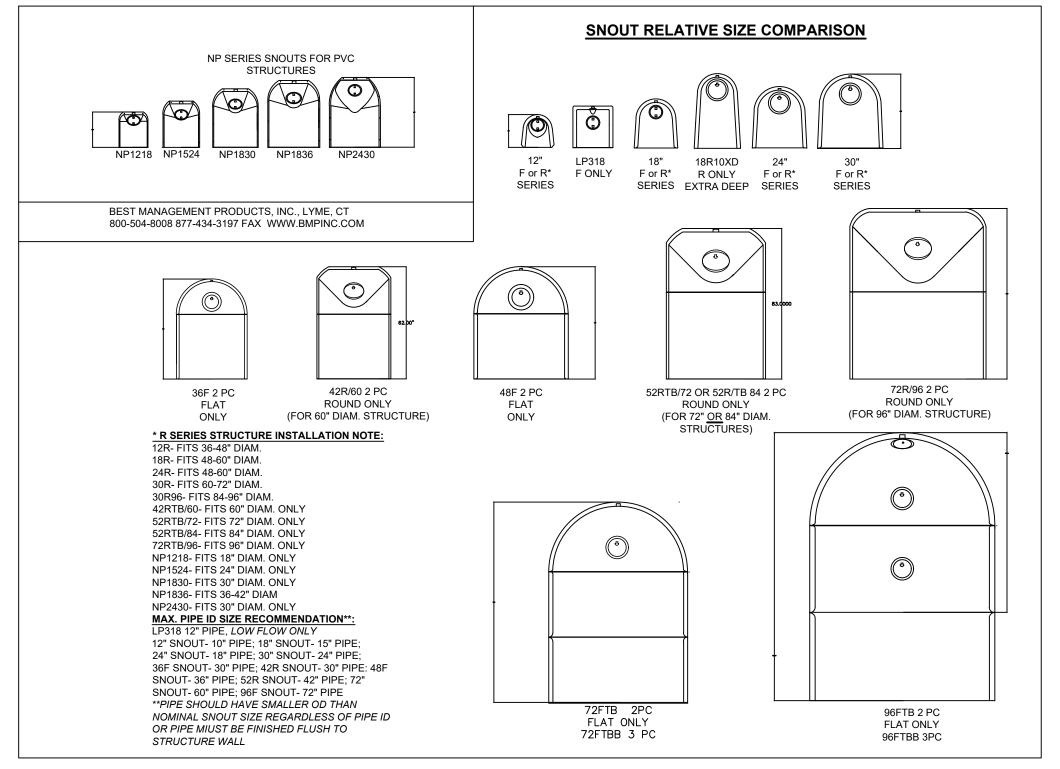

SNOU INSTA	T LLATION	J
INLET ID	BMP ID	SNOUT SIZE
I-100	002	18F
I-101	003	18F

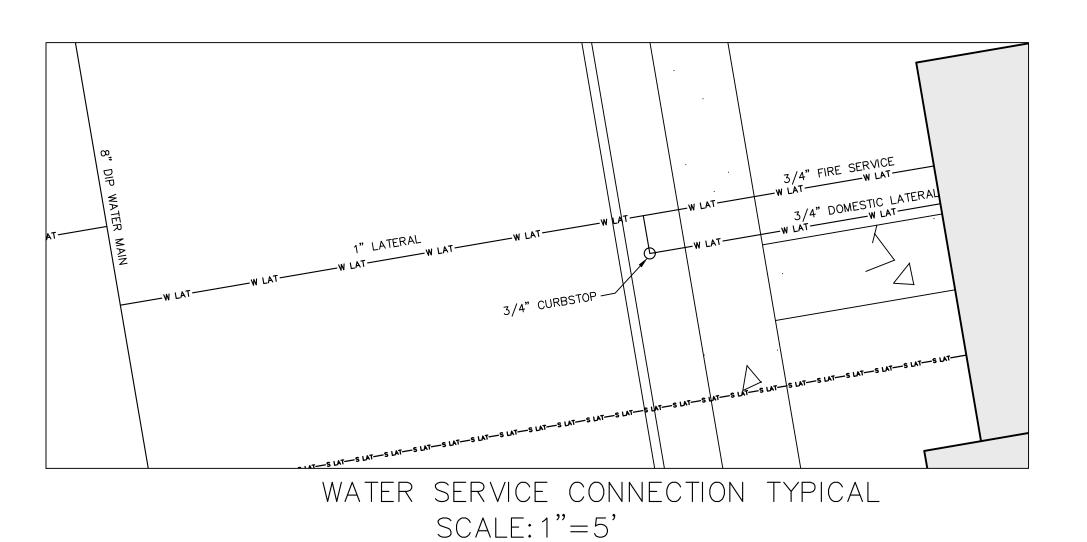

1" = 30'

### SANITARY SEWER NOTES

- ALL SANITARY SEWER MATERIAL AND APPURTENANCES TO BE DEDICATED TO THE CITY MUST BE CONSTRUCTED IN ACCORDANCE WITH THE CITY OF BETHLEHEM CONSTRUCTION SPECIFICATIONS, AS AMENDED AND THE PA DEP DOMESTIC WASTEWATER FACILITIES MANUAL, LATEST REVISION.
- ALL SANITARY SEWER PIPE, FITTINGS, AND APPURTENANCES MUST BE SDR-26 OR 35 PVC, UNLESS NOTED OTHERWISE.
- CONNECTION TO EXISTING SANITARY SEWER MANHOLE MUST BE MADE USING WATERTIGHT CONNECTION. EXISTING SANITARY SEWER CONNECTIONS SHALL BE CAPPED AT THE MAIN PRIOR TO DEMOLITION. CAPPING PERMITS SHALL BE OBTAINED FROM THE

### **GENERAL UTILITY NOTES**

CITY OF BETHLEHEM ENGINEERING BUREAU.

- THE DEVELOPER IS RESPONSIBLE TO SECURE AND PAY FOR ALL ESTABLISHED CITY APPLICATION, ALLOCATION AND TRANSMISSION AND TREATMENT FEES OR PERMITS NECESSARY FOR THE CONNECTION OF THE
- WATER AND SEWER SYSTEMS TO THE CITY PUBLIC SYSTEMS. ALL DEVELOPMENT CONSTRUCTION IMPROVEMENTS ARE SUBJECT TO QUALITY CONTROL INSPECTION BY THE CITY OR THEIR ASSIGNED AGENTS. ALL WORK CONSTRUCTED WITHOUT QUALITY CONTROL INSPECTION WILL BE SUBJECT TO REJECTION AND REMOVAL AND REMOVAL AND RECONSTRUCTION. THE CONTRACTOR SHALL NOTIFY THE CITY A MINIMUM OF 3 DAYS PRIOR TO ANY CONSTRUCTION OPERATIONS WITHIN THE CITY RIGHT-OF-WAY OR AFFECTING A CITY UTILITY.

#### WATER UTILITY NOTES

- ALL WATER SERVICE LATERALS MUST BE INSTALLED FROM THE MAIN, CORPORATION STOP TO THE CURB STOP AT THE CITY RIGHT-OF-WAY
- WITHOUT A SPLICE CONNECTION. THE CONTRACTOR SHALL NOT OPERATE EXISTING VALVES, FIRE HYDRANTS, ETC., WITHIN THE CITY'S WATER SYSTEM. ARRANGEMENTS SHALL BE MADE THROUGH THE CITY FOR OPERATION.
- 3. ALL WATER SYSTEM MATERIALS, APPURTENANCES AND CONSTRUCTION WITHIN THE CITY RIGHT-OF-WAY MUST BE IN COMPLIANCE WITH THE CITY OF BETHLEHEM CONSTRUCTION SPECIFICATIONS, AS AMENDED AND THE PA DEP PUBLIC WATER SUPPLY MANUAL, LATEST EDITION.
- 4. ALL WATER LATERALS AND APPURTENANCES MUST MAINTAIN A MINIMUM OF 4 FEET COVER FROM FINISHED GRADE AND SHALL BE DUCTILE IRON



CHECKED:

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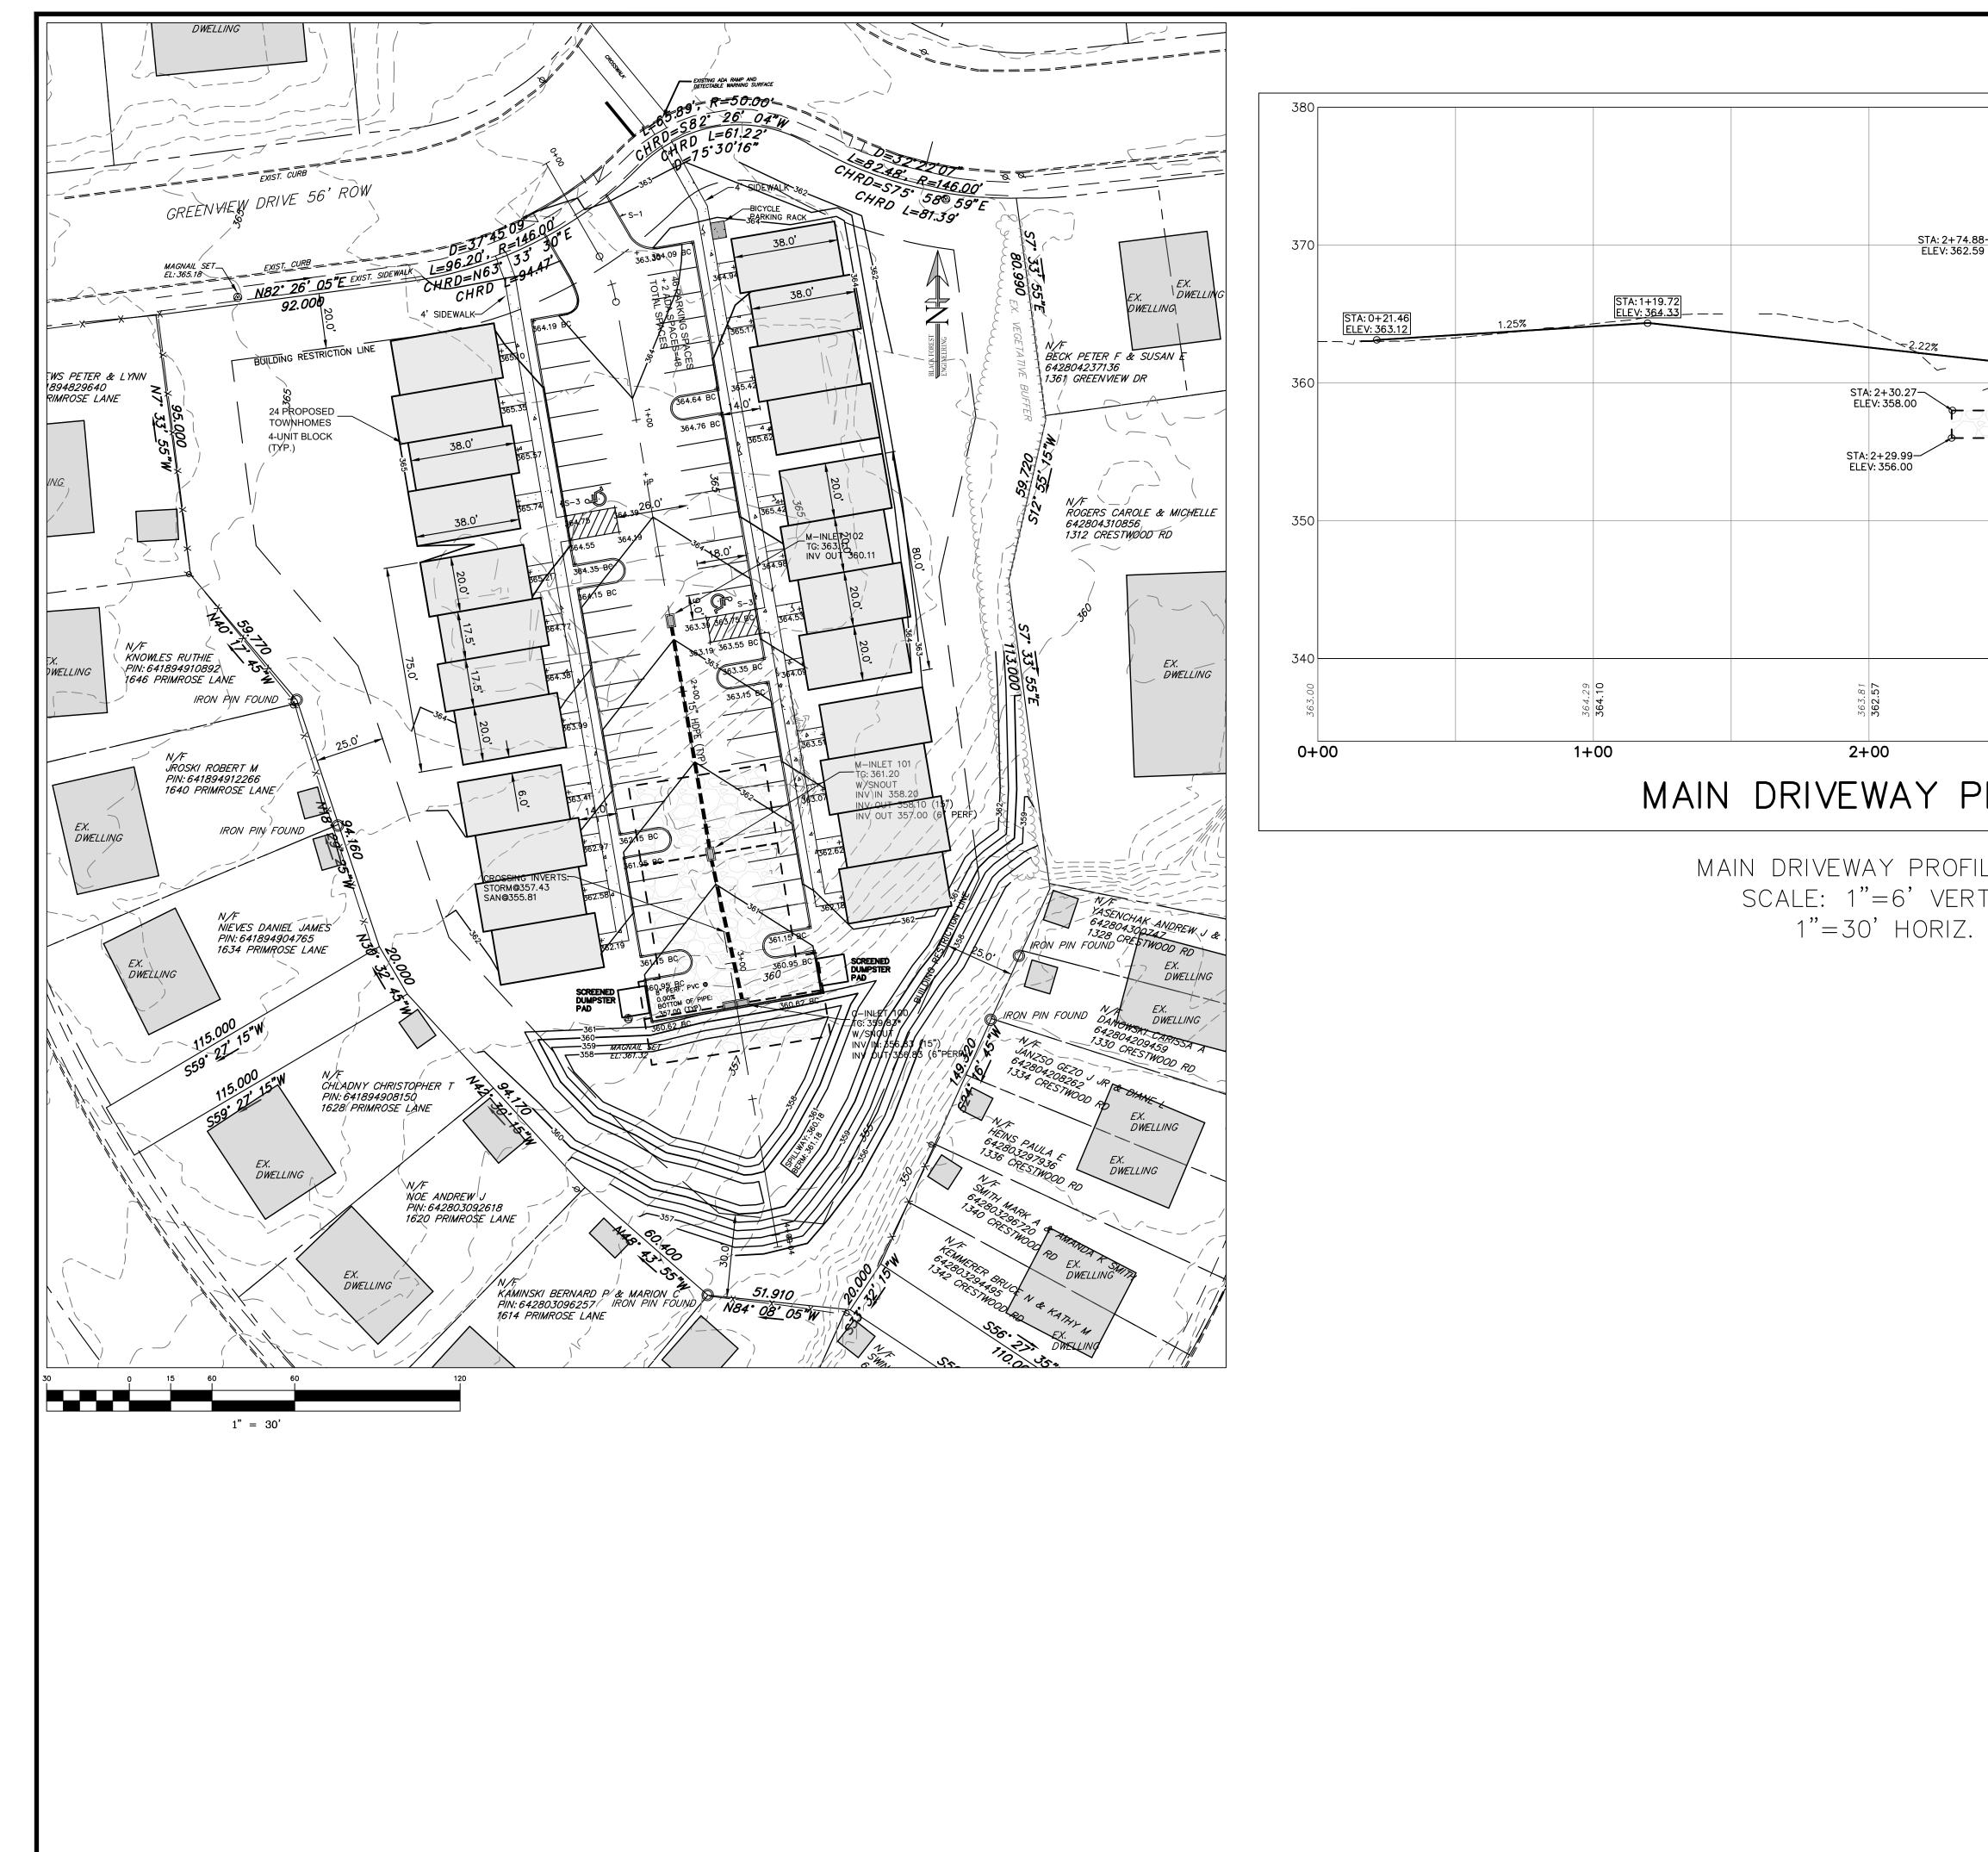
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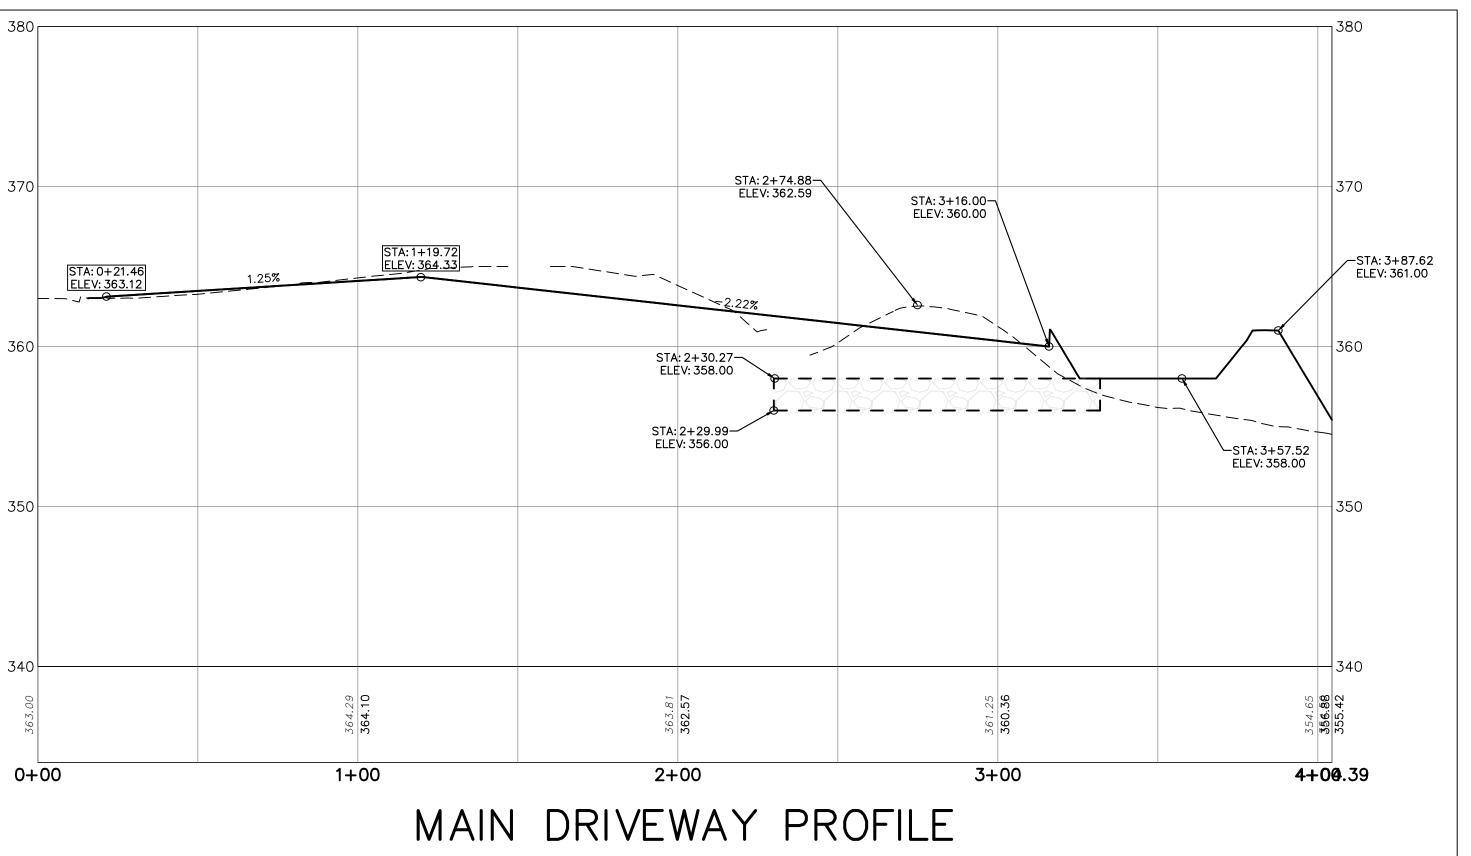
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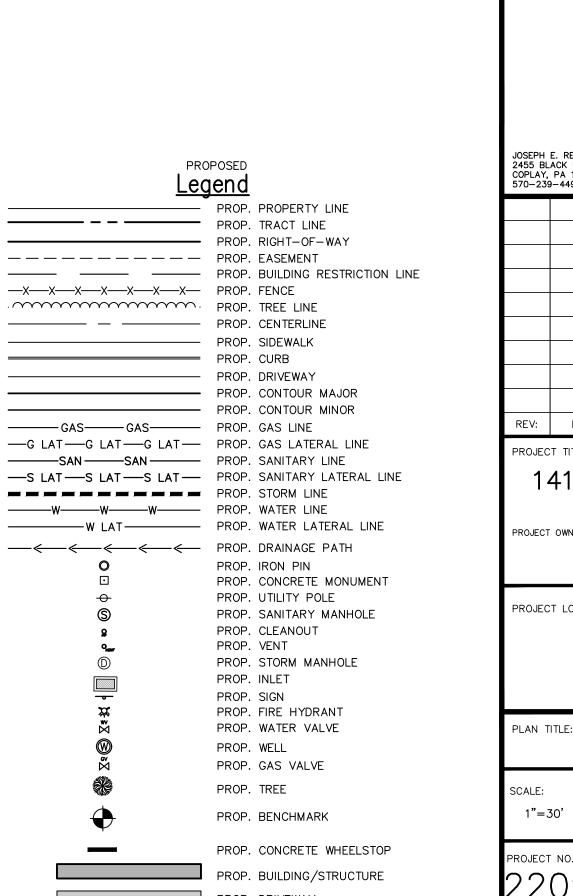
ROJECT NO.

JER





MAIN DRIVEWAY PROFILE SCALE: 1"=6' VERT.



PROPOSED <u>Legend</u>

PROP. TRACT LINE

— — — — — — — PROP. EASEMENT

PROP. CURB

—X—X—X—X—X—X— PROP. FENCE PROP. TREE LINE 

——←—←—← PROP. DRAINAGE PATH

PROP. STORM LINE 

--- PROP. PROPERTY LINE

PROP. RIGHT-OF-WAY

PROP. SIDEWALK

PROP. CONTOUR MINOR

----- PROP. DRIVEWAY PROP. CONTOUR MAJOR

PROP. IRON PIN

PROP. UTILITY POLE

PROP. FIRE HYDRANT PROP. WATER VALVE

PROP. CLEANOUT PROP. VENT

PROP. INLET

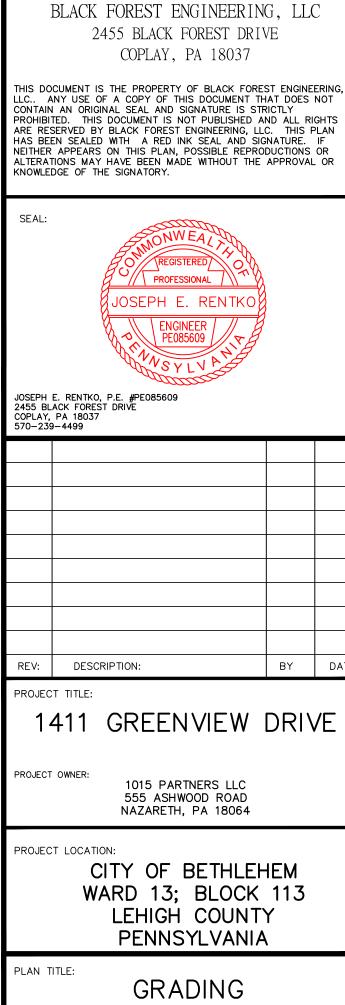
PROP. SIGN

PROP. WELL PROP. GAS VALVE

PROP. TREE

PROP. BENCHMARK

PROP. DRIVEWAY



CHECKED:

JER

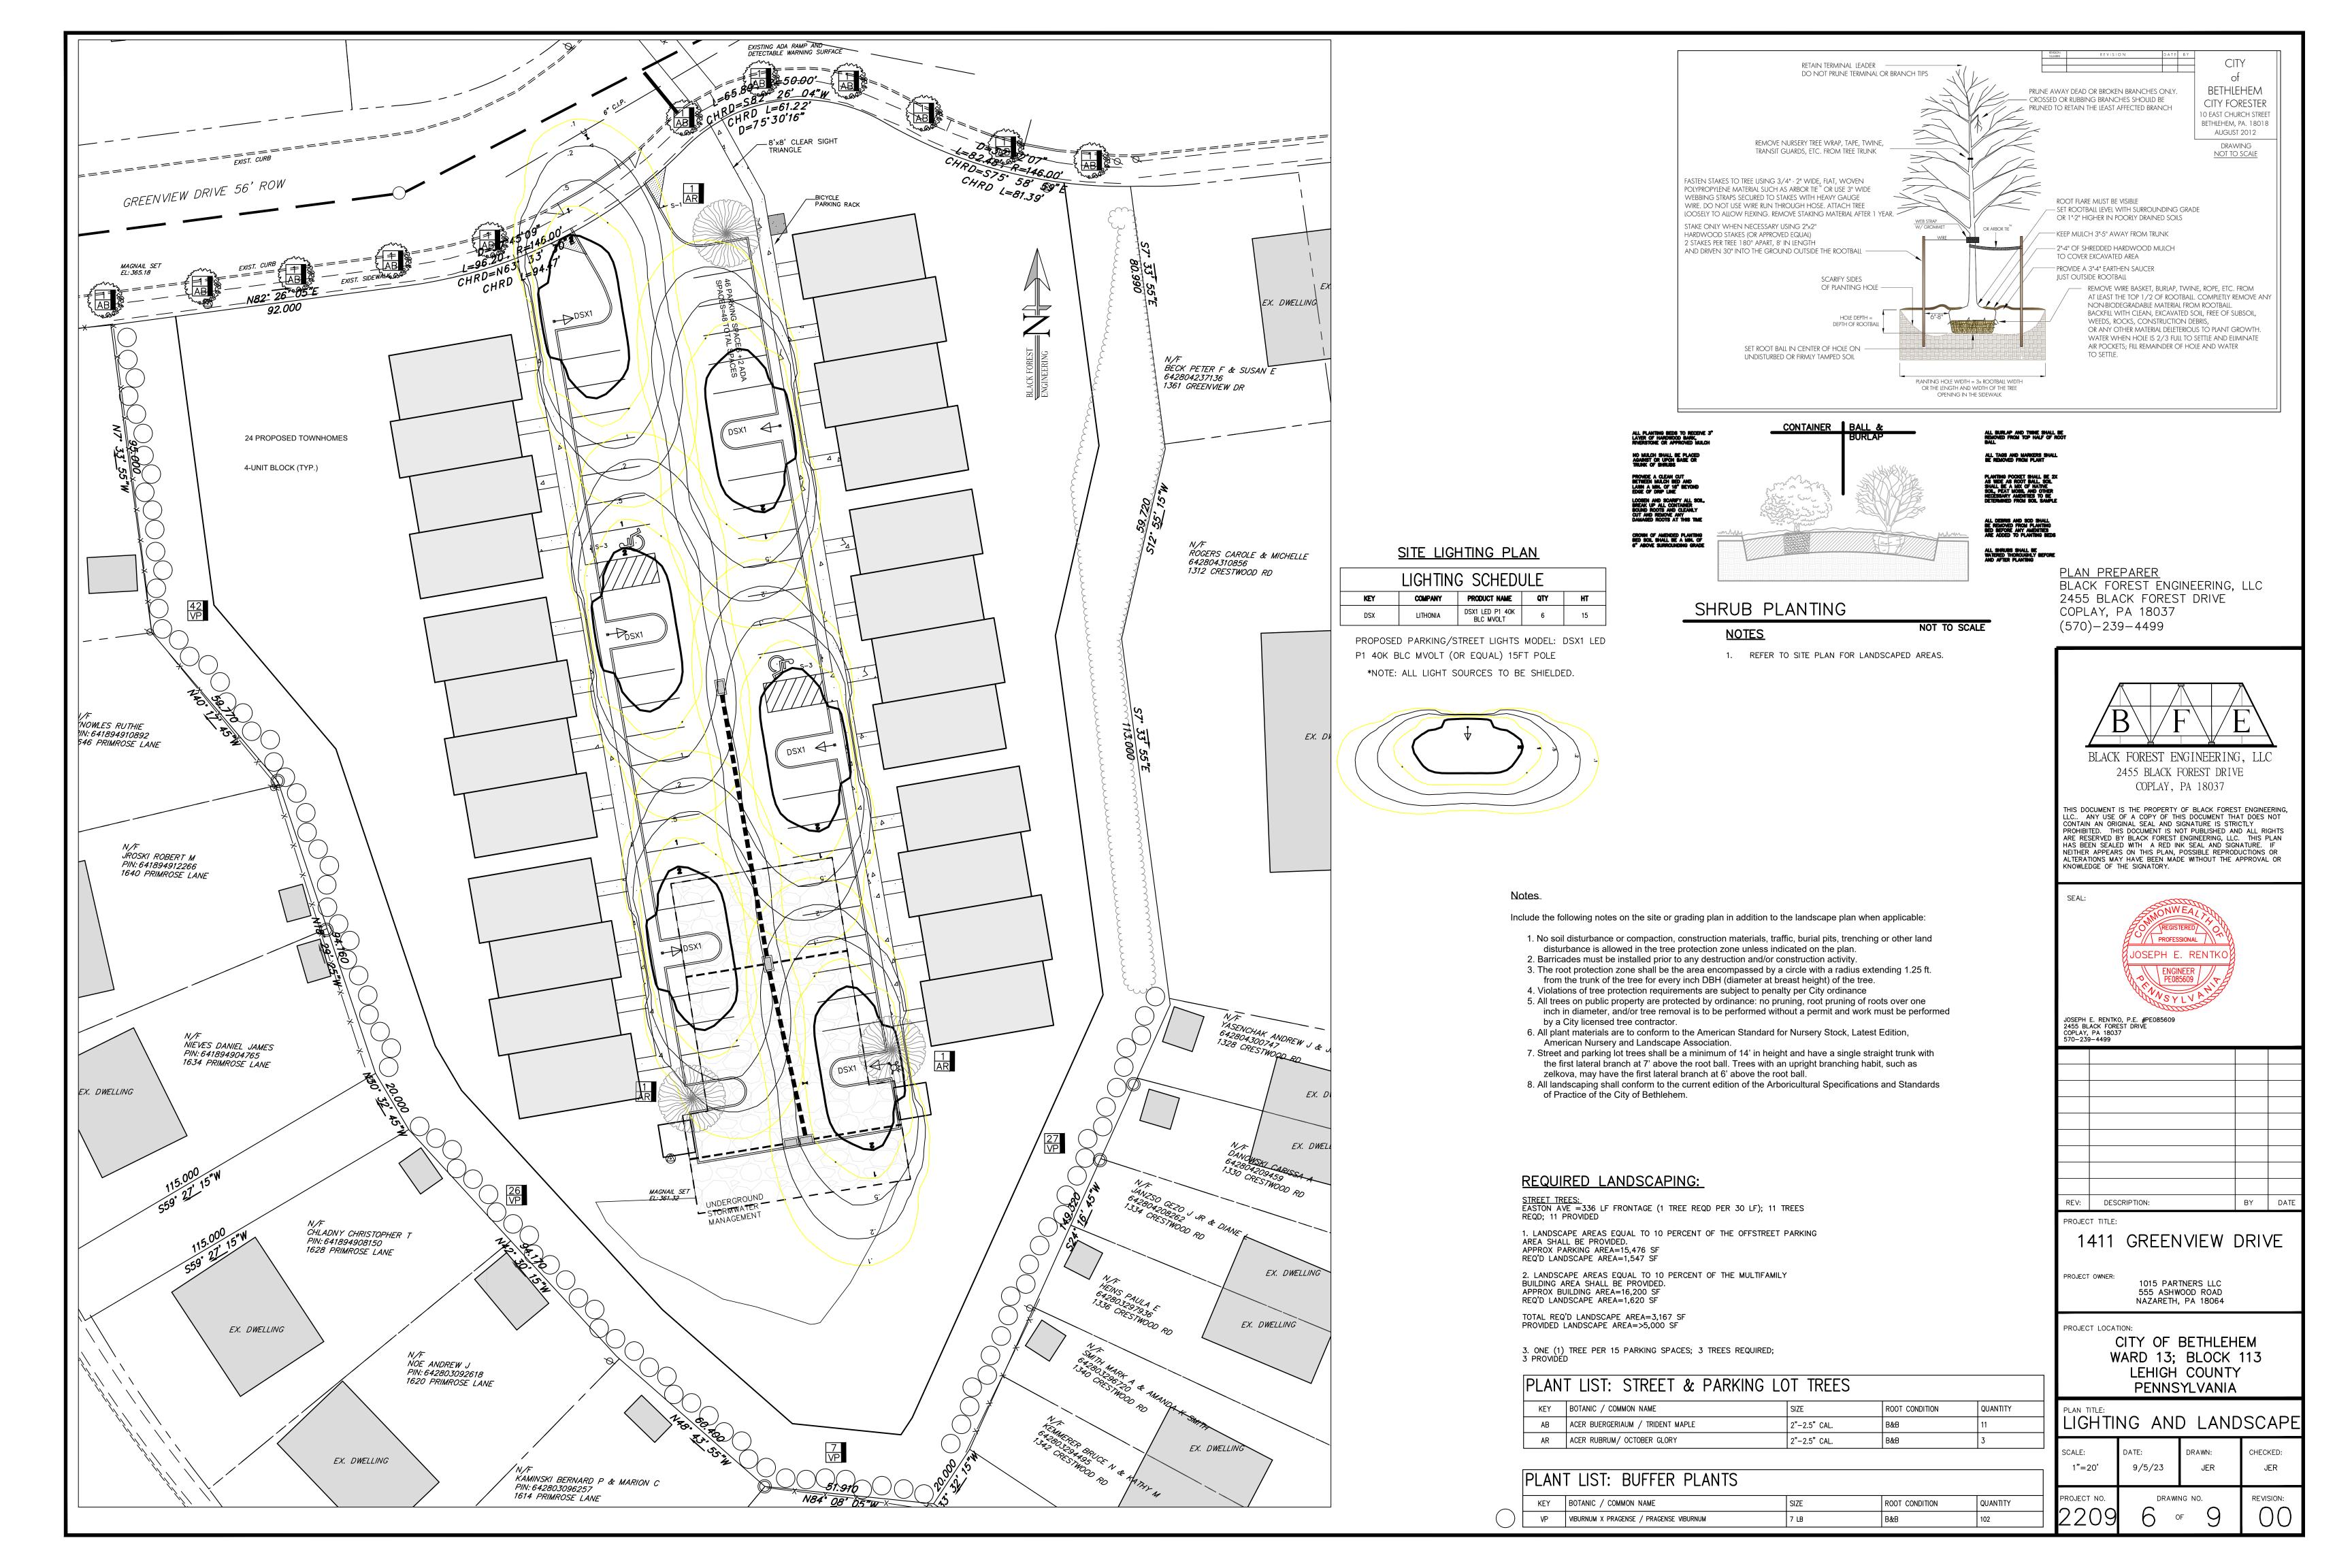
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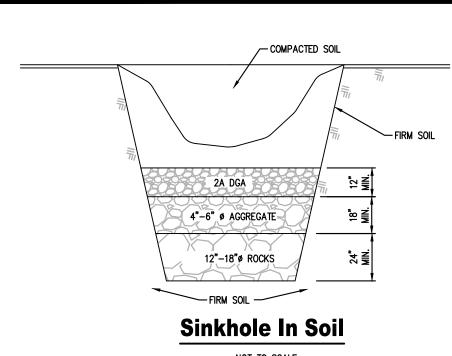
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DRAWING NO.

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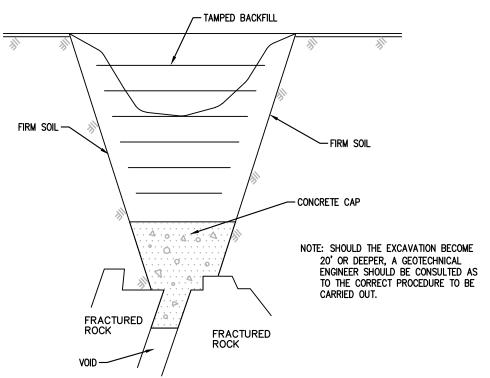
9/5/23






NOT TO SCALE

- 1. THE REPAIR TECHNIQUES AS DESCRIBED BELOW ARE SUITABLE ONLY IF THE SINKHOLE IS LOCATED IN AN OPEN AREA. IF THE SINKHOLE IS LOCATED UNDER OR NEAR A STRUCTURE OR A BUILDING, COMPACTION GROUTING MAY BE NECESSARY FOR REMEDIATION, AS DETERMINED BY A GEOTECHNICAL ENGINEER LICENSED IN THE COMMONWEALTH OF PENNSYLVANIA
- 2. EXCAVATE DOWN TO ROCK TO SINKHOLE THROAT OR TO A DEPTH OF 15 FEET BELOW GRADE, WHICHEVER
- 3. IF ROCK IS ENCOUNTERED WITHIN 10 FEET, STOP EXCAVATION. THE LIMIT OF EXCAVATION SHALL BE DETERMINED BY THE GEOTECHNICAL ENGINEER. GENERALLY, A ZONE OF SOFT, IN-FILL MATERIAL WILL BE FOUND WHICH COVERS MOST OF THE BOTTOM OF THE EXCAVATION. COVER THIS AREA WITH A GRADED ROCK FILTER AS SHOWN
- 4. BACKFILL HOLE WITH RELATIVELY IMPERMEABLE CLAY SOIL. COMPACT SOIL IN 6" LIFTS WITH A POWER TAMPER OR RAMMER TO AT LEAST 95% OF THE STANDARD PROCTOR.
- 5. BACKFILL HOLE ABOVE EXISTING GRADE TO DIVERT SURFACE WATER.





#### Sinkhole In Rock

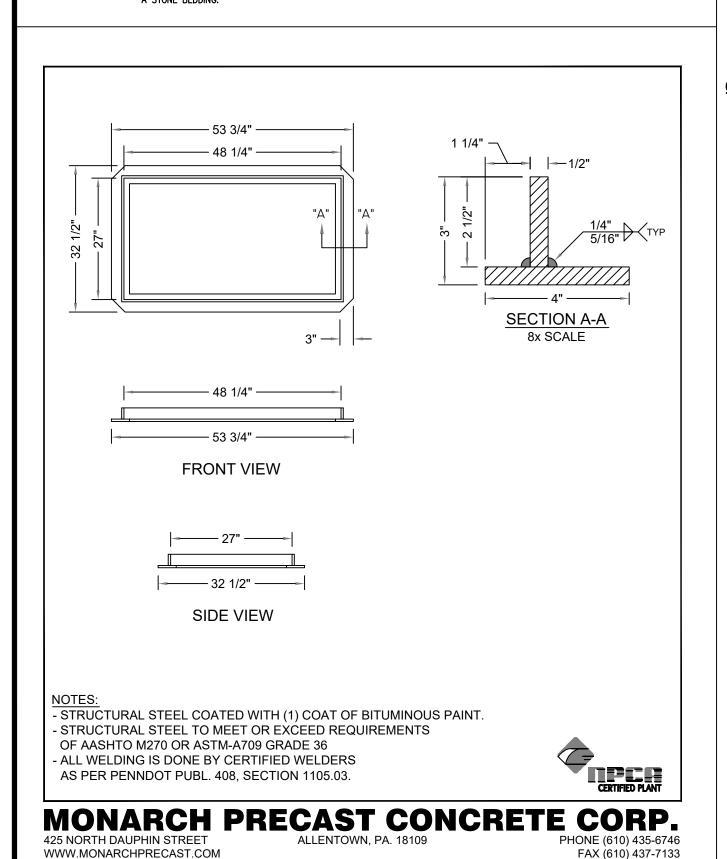
- 1. THE REPAIR TECHNIQUES AS DESCRIBED BELOW ARE SUITABLE ONLY IF THE SINKHOLE IS LOCATED IN AN OPEN AREA. IF THE SINKHOLE IS LOCATED UNDER OR NEAR A STRUCTURE OR A BUILDING, COMPACTION GROUTING MAY BE NECESSARY FOR REMEDIATION, AS DETERMINED BY A GEOTECHNICAL ENGINEER LICENSED IN THE
- 2. EXCAVATE DOWN TO BEDROCK OR TO THE SINKHOLE THROAT
- 3. EXPOSE THE ROCK SURFACE BY WASHING THE AREA WITH A SMALL HOSE WATER SPRAY AND INSTALL HIGHSUMP CEMENT INTO VOIDS AND CREVICES UNTIL VOIDS ARE FILLED AND A CAP COVERS THE AREA. THE LIMIT OF EXCAVATION AND CONCRETE SHALL BE DETERMINED BY THE ENGINEER.
- 4. AFTER CONCRETE HAS SET OVERNIGHT, BACKFILL HOLE WITH RELATIVELY IMPERMEABLE CLAY SOIL. COMPACT SOIL IN 6" LIFTS WITH A POWER TAMPER OR RAMMER TO AT LEAST 95% OF THE STANDARD PROCTOR. THE TOP THREE(3) FEET SHALL BE BACKFILLED WITH 2RC CRUSHED AGGREGATE.
- 5. BACKFILL HOLE ABOVE EXISTING GRADE TO DIVERT SURFACE WATER.
- 6. WHEN SINKHOLE IS UNDER A PROPOSED UTILITY. CONCRETE IS TO BE SET 6" BELOW THE UTILITY TO ALLOW FOR A STONE BEDDING.



3" M ALTERNATE STEEL FRAME

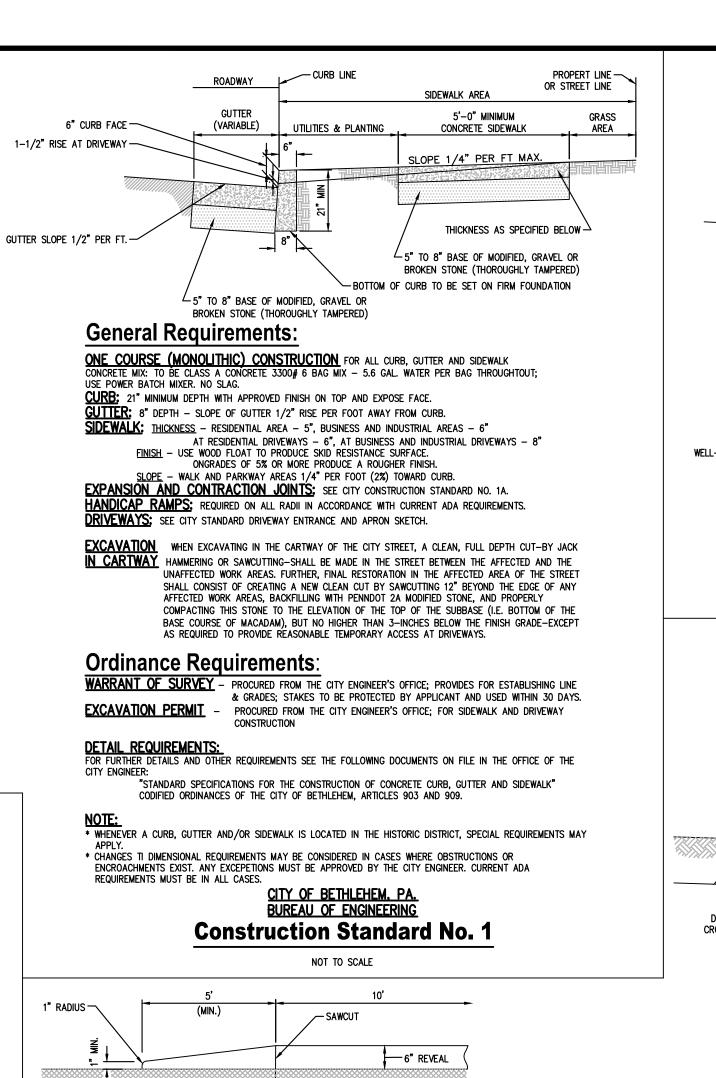

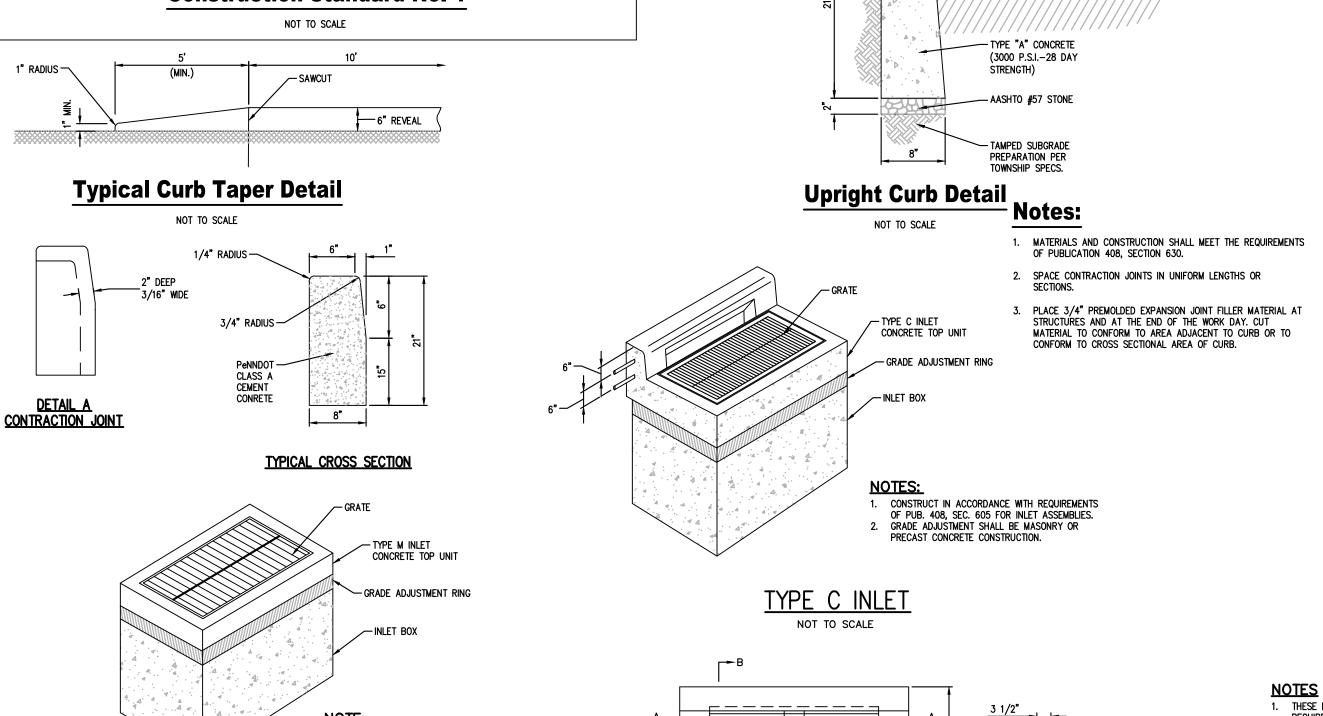

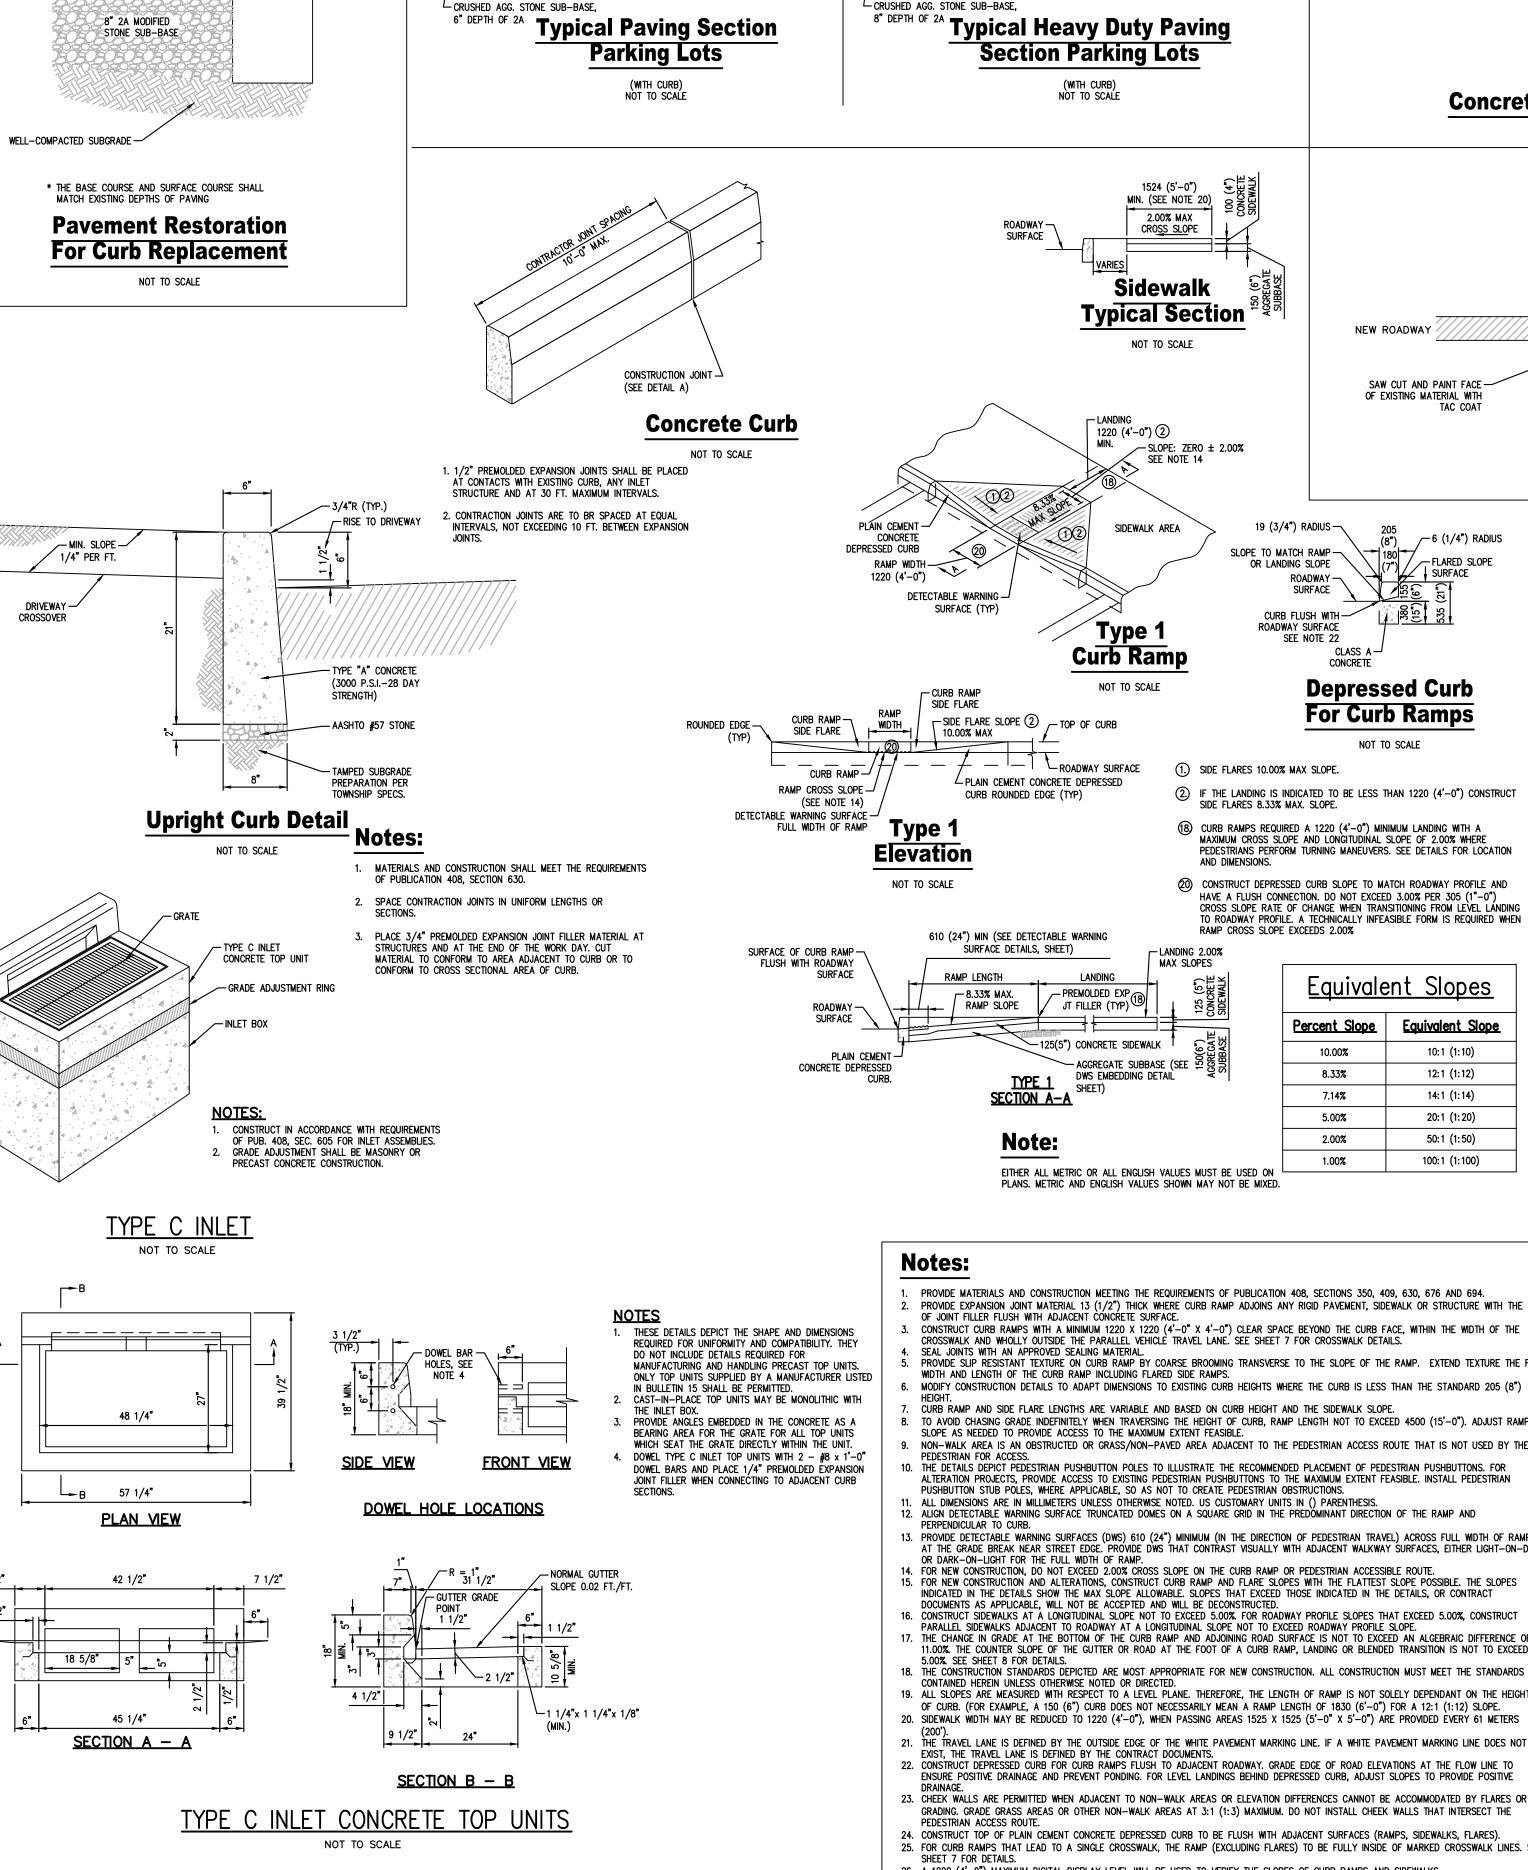

- DEPRESSED CURB

— STANDARD CURE

SLOPES VARY

∠ID-2A MITUMINOUS WEARING

9.5 mm SUPERPAVE WEARING

COURSE 1-1/2" DEPTH

0 - 0.3 ESL'S SRL- M

19mm SUPERPAVE BINDER

PG 64-22

BINDER, 2" DEPTH

3(MAX)

CONCRETE/

- WELL COMPACTED

BELGIAN CURI

FOR CURB RAMP

— SEAL JOINT WITH

(12"MIN WIDTH)

BM-1 OR A-1 BIT. GUTTER SEAL-

-1-1/2" 9.5mm

SÚPERPAVE

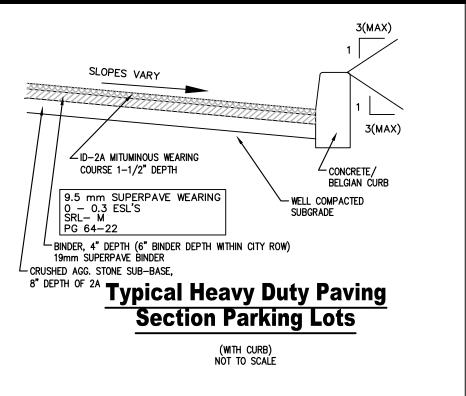
3" 19mm SUPERPAVE

SUPERPAVE BASE COURSE

BINDER COURSE

4-1/2" 37mm

WEARING COURSE



1524 (5'-0")

MIN. (SEE NOTE 20)

2.00% MAX

CRO<u>SS SLO</u>PE

Sidewalk

**Typical Section** 

NOT TO SCALE

✓ SLOPE: ZERO ± 2.00%

SEE NOTE 14

1220 (4'-0") ②

SIDEWALK AREA

Type 1

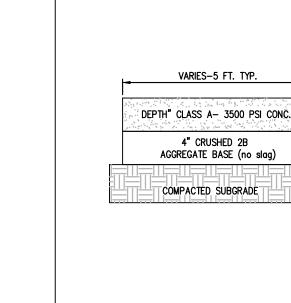
Curb Ramp

NOT TO SCALE

(1)2

∠PLAIN CEMENT CONCRETE DEPRESSED

CURB ROUNDED EDGE (TYP)



VARIES-5 FT. TYP.

4" CRUSHED 2B

COMPACTED SUBGRADE

AGGREGATE BASE (no slag)

#### -DEPTH = 4" ONSITENote: CONSTRUCT IN SECTIONS NOT OVER 10 FEET WITH VERTICAL JOINTS FOR FULL DEPTH OF PAVEMENT. THE JOINTS SHALL BE MADE BY REMOVABLE METAL

PLATES SO THAT ADJACENT BLOCKS WILL BE MADE ON DIFFERENT DAYS. EXPANSION JOINTS LOCATED 30' O.C.

TOOLED JOINTS LOCATED 5' O.C. SIDEWALK IS TO BE LIGHT BROOM FINISHED IN THE DIRECTION OF SIDEWALK WIDTH ALL MATERIAL AND CONSTRUCTION PROCEDURES SHALE COMPLY WITH THE CITY OF BETHLEHEM

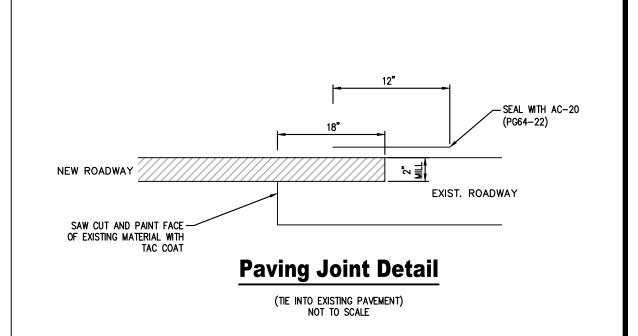
6. ALL SIDEWALK OUTSIDE OF THE ROW SHALL USE

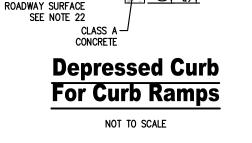
FOLLOW THE CITY STANDARD "CONSTRUCTION

ABOVE DETAIL. ALL SIDEWALK WITHIN THE ROW SHALL

**Concrete Sidewalk Detail** 

NOT TO SCALE





\_6 (1/4") RADIUS

FLARED SLOPE

SURFACE

SIDE FLARES 10.00% MAX SLOPE.

19 (3/4") RADIUS —

SLOPE TO MATCH RAMP-

OR LANDING SLOPE

ROADWAY -


SURFACE

CURB FLUSH WITH-

- (2) IF THE LANDING IS INDICATED TO BE LESS THAN 1220 (4'-0") CONSTRUCT SIDE FLARES 8.33% MAX. SLOPE.
- (18) CURB RAMPS REQUIRED A 1220 (4'-0") MINIMUM LANDING WITH A MAXIMUM CROSS SLOPE AND LONGITUDINAL SLOPE OF 2.00% WHERE PEDESTRIANS PERFORM TURNING MANEUVERS. SEE DETAILS FOR LOCATION
- (20) CONSTRUCT DEPRESSED CURB SLOPE TO MATCH ROADWAY PROFILE AND HAVE A FLUSH CONNECTION. DO NOT EXCEED 3.00% PER 305 (1"-0") CROSS SLOPE RATE OF CHANGE WHEN TRANSITIONING FROM LEVEL LANDING TO ROADWAY PROFILE. A TECHNICALLY INFEASIBLE FORM IS REQUIRED WHEN RAMP CROSS SLOPE EXCEEDS 2.00%

SURFACE DETAILS, SHEET)  LANDING 2.00%  MAX SLOPES		
RAMP LENGTH	<u>Equivale</u>	ent Slopes
	Percent Slope	<u>Equivalent Slope</u>
125(5") CONCRETE SIDEWALK  AGGREGATE SUBBASE (SEE SUBBASE (SEE SUBBASE)  DWS EMBEDDING DETAIL	10.00%	10:1 (1:10)
14DF 1	8.33%	12:1 (1:12)
SECTION A-A SHEET)	7.14%	14:1 (1:14)
	5.00%	20:1 (1:20)
Note:	2.00%	50:1 (1:50)
EITHER ALL METRIC OR ALL ENGLISH VALUES MUST BE USED ON	1.00%	100:1 (1:100)

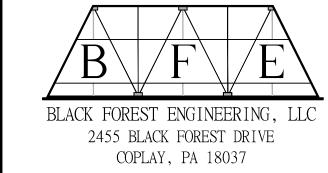PLANS. METRIC AND ENGLISH VALUES SHOWN MAY NOT BE MIXED.



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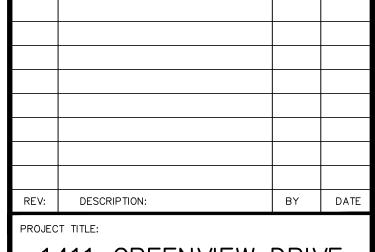
SEAL:

JOSEPH E. RENTKO, P.E. #PE085609 2455 BLACK FOREST DRIVE COPLAY, PA 18037 570-239-4499

- PROVIDE MATERIALS AND CONSTRUCTION MEETING THE REQUIREMENTS OF PUBLICATION 408, SECTIONS 350, 409, 630, 676 AND 694. PROVIDE EXPANSION JOINT MATERIAL 13 (1/2") THICK WHERE CURB RAMP ADJOINS ANY RIGID PAVEMENT, SIDEWALK OR STRUCTURE WITH THE TOP OF JOINT FILLER FLUSH WITH ADJACENT CONCRETE SURFACE. CONSTRUCT CURB RAMPS WITH A MINIMUM 1220 X 1220 (4'-0" X 4'-0") CLEAR SPACE BEYOND THE CURB FACE, WITHIN THE WIDTH OF THE
- CROSSWALK AND WHOLLY OUTSIDE THE PARALLEL VEHICLE TRAVEL LANE. SEE SHEET 7 FOR CROSSWALK DETAILS. SEAL JOINTS WITH AN APPROVED SEALING MATERIAL. PROVIDE SLIP RESISTANT TEXTURE ON CURB RAMP BY COARSE BROOMING TRANSVERSE TO THE SLOPE OF THE RAMP. EXTEND TEXTURE THE FULL WIDTH AND LENGTH OF THE CURB RAMP INCLUDING FLARED SIDE RAMPS.
- CURB RAMP AND SIDE FLARE LENGTHS ARE VARIABLE AND BASED ON CURB HEIGHT AND THE SIDEWALK SLOPE. 8. TO AVOID CHASING GRADE INDEFINITELY WHEN TRAVERSING THE HEIGHT OF CURB, RAMP LENGTH NOT TO EXCEED 4500 (15'-0"). ADJUST RAMP SLOPE AS NEEDED TO PROVIDE ACCESS TO THE MAXIMUM EXTENT FEASIBLE.
- NON-WALK AREA IS AN OBSTRUCTED OR GRASS/NON-PAVED AREA ADJACENT TO THE PEDESTRIAN ACCESS ROUTE THAT IS NOT USED BY THE THE DETAILS DEPICT PEDESTRIAN PUSHBUTTON POLES TO ILLUSTRATE THE RECOMMENDED PLACEMENT OF PEDESTRIAN PUSHBUTTONS. FOR ALTERATION PROJECTS, PROVIDE ACCESS TO EXISTING PEDESTRIAN PUSHBUTTONS TO THE MAXIMUM EXTENT FEASIBLE. INSTALL PEDESTRIAN PUSHBUTTON STUB POLES, WHERE APPLICABLE, SO AS NOT TO CREATE PEDESTRIAN OBSTRUCTIONS.
- 11. ALL DIMENSIONS ARE IN MILLIMETERS UNLESS OTHERWISE NOTED. US CUSTOMARY UNITS IN () PARENTHESIS. 12. ALIGN DETECTABLE WARNING SURFACE TRUNCATED DOMES ON A SQUARE GRID IN THE PREDÖMINANT DIRECTION OF THE RAMP AND
- 13. PROVIDE DETECTABLE WARNING SURFACES (DWS) 610 (24") MINIMUM (IN THE DIRECTION OF PEDESTRIAN TRAVEL) ACROSS FULL WIDTH OF RAMP AT THE GRADE BREAK NEAR STREET EDGE. PROVIDE DWS THAT CONTRAST VISUALLY WITH ADJACENT WALKWAY SURFACES, EITHER LIGHT-ON-DARK
- OR DARK-ON-LIGHT FOR THE FULL WIDTH OF RAMP. 14. FOR NEW CONSTRUCTION, DO NOT EXCEED 2.00% CROSS SLOPE ON THE CURB RAMP OR PEDESTRIAN ACCESSIBLE ROUTE
- 15. FOR NEW CONSTRUCTION AND ALTERATIONS, CONSTRUCT CURB RAMP AND FLARE SLOPES WITH THE FLATTEST SLOPE POSSIBLE. THE SLOPES INDICATED IN THE DETAILS SHOW THE MAX SLOPE ALLOWABLE. SLOPES THAT EXCEED THOSE INDICATED IN THE DETAILS, OR CONTRACT DOCUMENTS AS APPLICABLE, WILL NOT BE ACCEPTED AND WILL BE DECONSTRUCTED.
- 16. CONSTRUCT SIDEWALKS AT A LONGITUDINAL SLOPE NOT TO EXCEED 5.00%, FOR ROADWAY PROFILE SLOPES THAT EXCEED 5.00%, CONSTRUCT PARALLEL SIDEWALKS ADJACENT TO ROADWAY AT A LONGITUDINAL SLOPE NOT TO EXCEED ROADWAY PROFILE SLOPE.

  17. THE CHANGE IN GRADE AT THE BOTTOM OF THE CURB RAMP AND ADJOINING ROAD SURFACE IS NOT TO EXCEED AN ALGEBRAIC DIFFERENCE OF 11.00%. THE COUNTER SLOPE OF THE GUTTER OR ROAD AT THE FOOT OF A CURB RAMP, LANDING OR BLENDED TRANSITION IS NOT TO EXCEED
- CONTAINED HEREIN UNLESS OTHERWISE NOTED OR DIRECTED.

  19. ALL SLOPES ARE MEASURED WITH RESPECT TO A LEVEL PLANE. THEREFORE, THE LENGTH OF RAMP IS NOT SOLELY DEPENDANT ON THE HEIGHT OF CURB. (FOR EXAMPLE, A 150 (6") CURB DOES NOT NECESSARILY MEAN A RAMP LENGTH OF 1830 (6'-0") FOR A 12:1 (1:12) SLOPE. 20. SIDEWALK WIDTH MAY BE REDUCED TO 1220 (4'-0"), WHEN PASSING AREAS 1525 X 1525 (5'-0" X 5'-0") ARE PROVIDED EVERY 61 METERS
- 21. THE TRAVEL LANE IS DEFINED BY THE OUTSIDE EDGE OF THE WHITE PAVEMENT MARKING LINE. IF A WHITE PAVEMENT MARKING LINE DOES NOT EXIST, THE TRAVEL LANE IS DEFINED BY THE CONTRACT DOCUMENTS. 22. CONSTRUCT DEPRESSED CURB FOR CURB RAMPS FLUSH TO ADJACENT ROADWAY. GRADE EDGE OF ROAD ELEVATIONS AT THE FLOW LINE TO ENSURE POSITIVE DRAINAGE AND PREVENT PONDING. FOR LEVEL LANDINGS BEHIND DEPRESSED CURB, ADJUST SLOPES TO PROVIDE POSITIVE
- 23. CHEEK WALLS ARE PERMITTED WHEN ADJACENT TO NON-WALK AREAS OR ELEVATION DIFFERENCES CANNOT BE ACCOMMODATED BY FLARES OR GRADING. GRADE GRASS AREAS OR OTHER NON-WALK AREAS AT 3:1 (1:3) MAXIMUM. DO NOT INSTALL CHEEK WALLS THAT INTERSECT THE
- 24. CONSTRUCT TOP OF PLAIN CEMENT CONCRETE DEPRESSED CURB TO BE FLUSH WITH ADJACENT SURFACES (RAMPS, SIDEWALKS, FLARES). 25. FOR CURB RAMPS THAT LEAD TO A SINGLE CROSSWALK, THE RAMP (EXCLUDING FLARES) TO BE FULLY INSIDE OF MARKED CROSSWALK LINES. SHEET 7 FOR DETAILS.
- 26. A 1220 (4'-0") MAXIMUM DIGITAL DISPLAY LEVEL WILL BE USED TO VERIFY THE SLOPES OF CURB RAMPS AND SIDEWALKS.



1411 GREENVIEW DRIVE


1015 PARTNERS LLC 555 ASHWOOD ROAD NAZARETH, PA 18064

PROJECT LOCATION: CITY OF BETHLEHEM WARD 13; BLOCK 113 LEHIGH COUNTY

PENNSYLVANIA

CONSTRUCTION DETAILS

SEE	SCALE:	DATE:	DRAWN:	CHECKED:
	AS NOTED	9/5/23	JER	JER
	project no. 2209	7 c	ng no. f 9	REVISION:

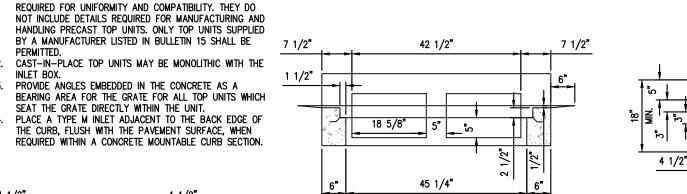

#### SECTION A - A SECTION B - I

TYPE M INLET CONCRETE TOP UNITS

48 1/4"

57 1/4"

PLAN VIEW

45 1/4"

. CONSTRUCT IN ACCORDANCE WITH

605, FOR INLET ASSEMBLIES.

CONSTRUCTION.

INLET BOX.

1 1/4"x 1 1/4"x 1/8" (MIN.)

YPE M INLET

NOT TO SCALE

2. GRADE ADJUSTMENT RINGS SHALL BE

MASONRY OR PRECAST CONCRETE

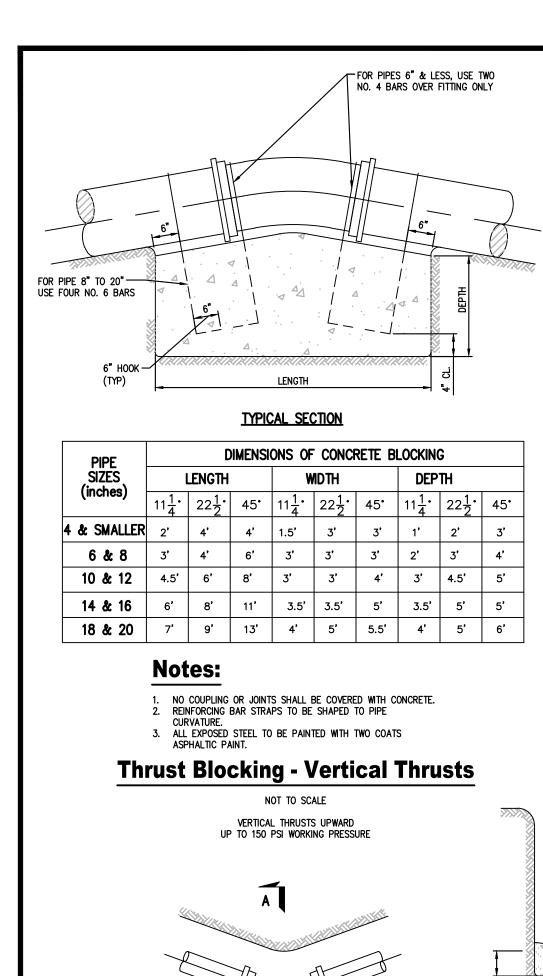
REQUIREMENTS OF PUB. 408, SECTION

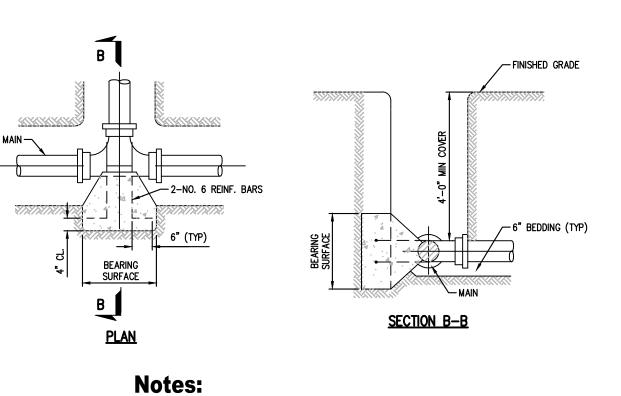
. THESE DETAILS DEPICT THE SHAPE AND DIMENSIONS

PROVIDE ANGLES EMBEDDED IN THE CONCRETE AS A

THE CURB, FLUSH WITH THE PAVEMENT SURFACE, WHEN

SEAT THE GRATE DIRECTLY WITHIN THE UNIT.






- SEE STANDARD DETAIL STANDARD DETAIL VII—27 FOR BEARING AREA REQUIRED.
   NO COUPLING OR JOINTS SHALL BE COVERED WITH CONCRETE.
   REINFORCING BAR STRAPS TO BE SHAPED TO PIPE


NOT TO SCALE


			BE/	ARING	AREA	REQU	JIRED,	SQUA	ARE F	EET		
Type of Bearing	D	4" and less DEGREE BEND DEGREE BEND DEGREE BEND DEGREE BEND										
Material and Allowable loads, psf	11 1/4	$22\frac{1}{2}$	45	90	11 <u>1</u>	$22\frac{1}{2}$	45	90	11 1/4	$22\frac{1}{2}$	45	90
LOOSE SAND OR MEDIUM CLAY - 2,000	1.0	2.0	2.7	4.0	1.5	3.0	6.0	10.0	3.0	6.2	12.0	22.0
PACKED GRAVEL AND SAND - 4,000	1.0	1.0	1.5	2.0	1.0	1.5	3.0	5.0	1.5	3.1	6.0	11.0
ROCK - 10,000	1.0	1.0	1.0	1.0	1.0	1.0	1.2	2.0	1.0	1.3	2.4	4.4
								-				

		BEARII	NG ARE	A REQU	JIRED, S	SQUARE	FEET	
Type of Bearing Material		<b>DEGREI</b>	nd 16" E BEND LECTION	<b>DEGREI</b>	18" and 20" EGREE BEND DEFLECTION			
and Allowable Loads	11 1/4	$22\frac{1}{2}$	45	90	11 <u>1</u>	$22\frac{1}{2}$	45	90
LOOSE SAND OR MEDIUM CLAY -2,000	6.0	12.0	22.5	40.0	9.5	19.0	37.0	67.0
PACKED GRAVEL AND SAND - 4,000	3.0	6.0	11.3	20.0	4.8	9.5	18.5	33.5
ROCK - 10,000	1.2	2.4	4.5	8.0	2.0	3.8	7.4	13.5

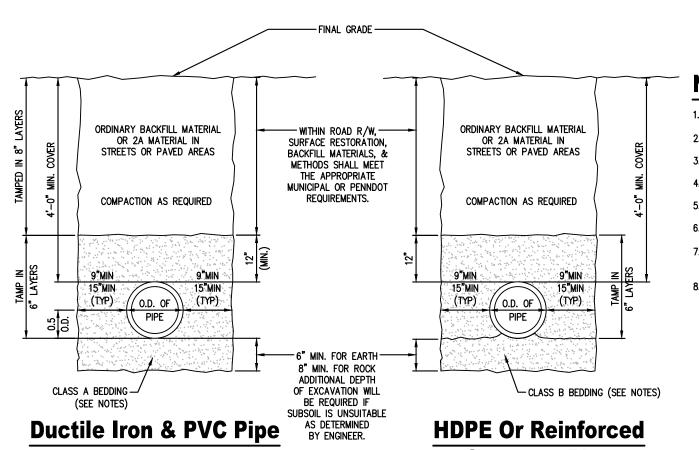

**Concrete Pipe Typical Trench Details** 

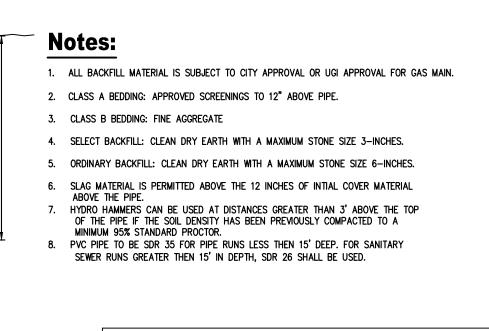

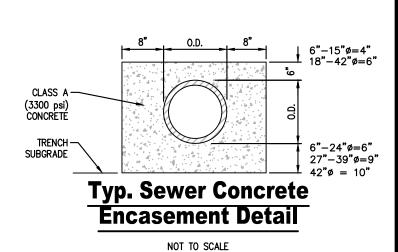



BLACK FOREST ENGINEERING, LLC 2455 BLACK FOREST DRIVE

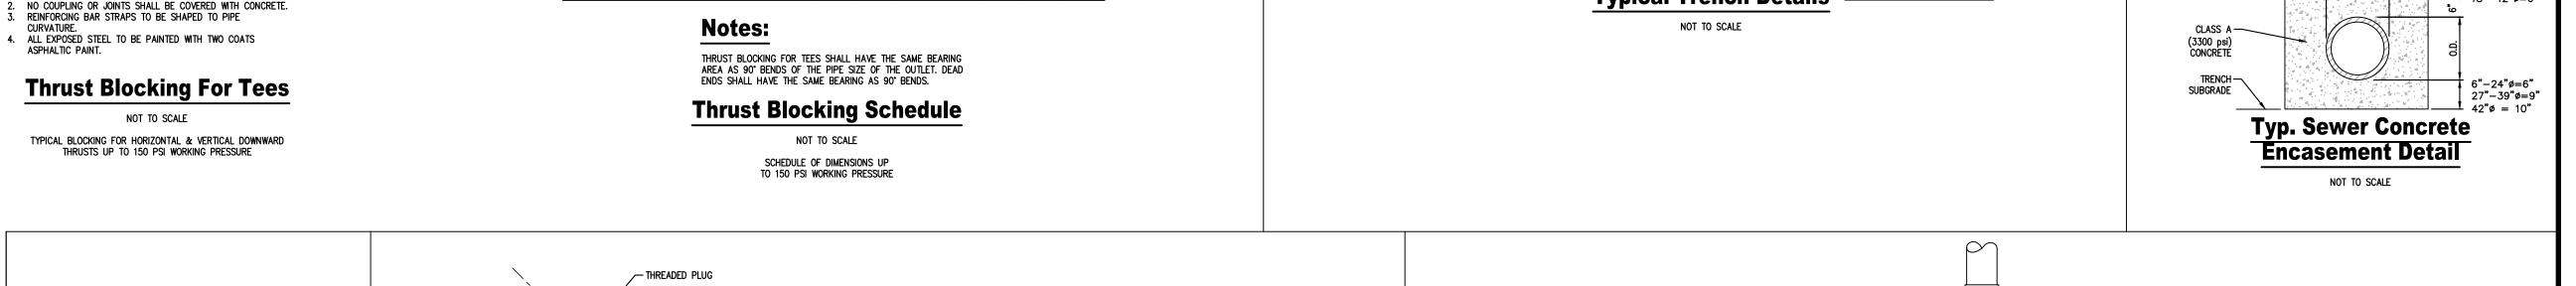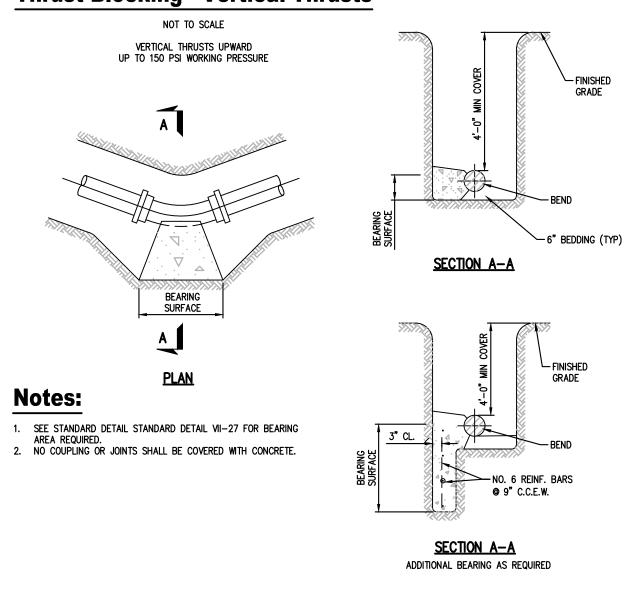COPLAY, PA 18037

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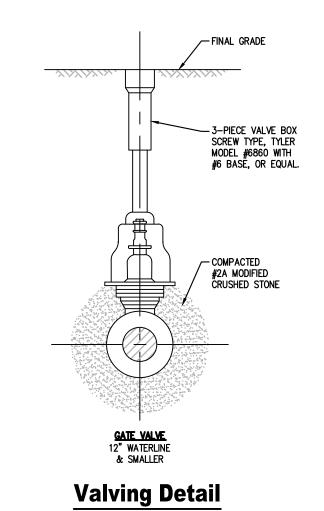
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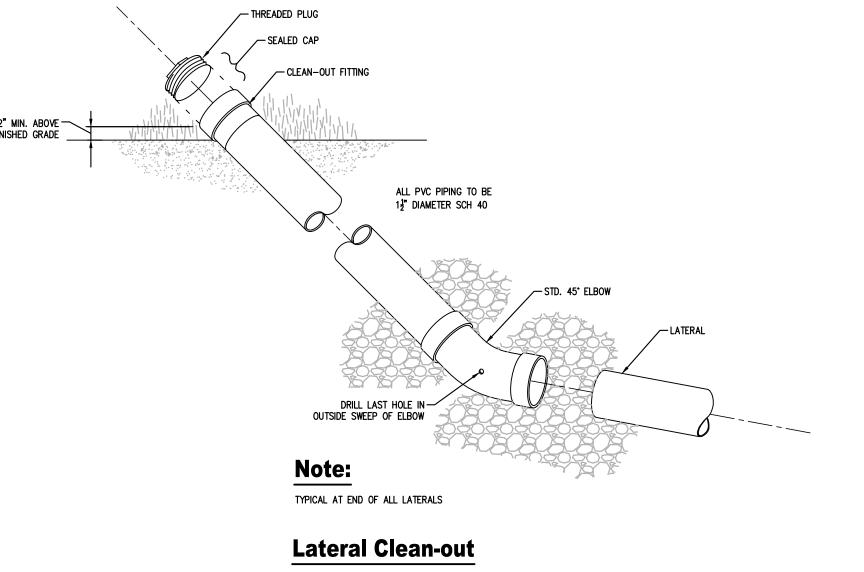
TYPICAL BLOCKING FOR HORIZONTAL & VERTICAL DOWNWARD THRUSTS UP TO 150 PSI WORKING PRESSURE

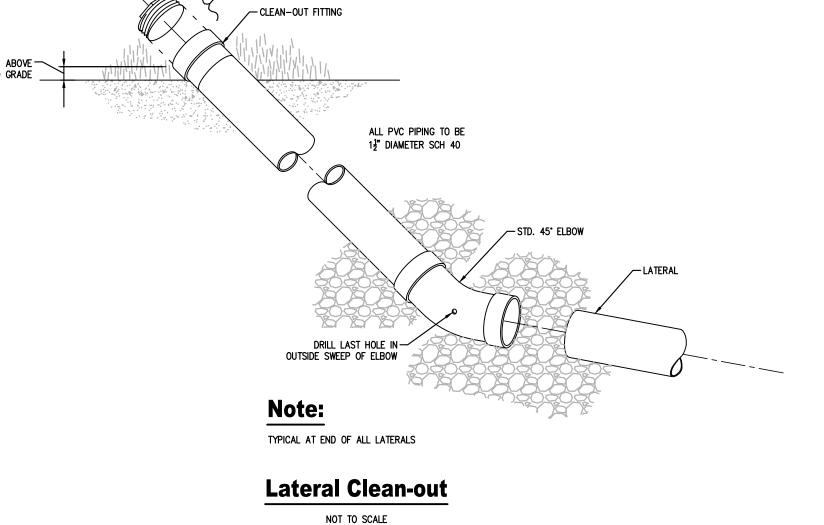


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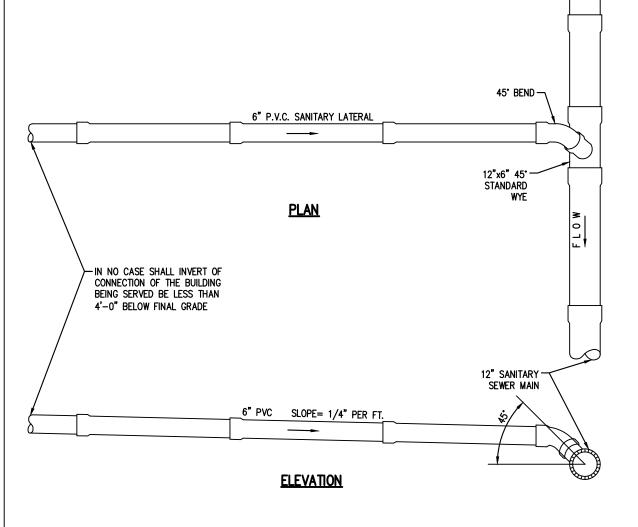
### NOTE:

- 1. VALVES 8" OR SMALLER SHALL BE RODDED TO A FITTING WITH 2 ALL-THREAD RODS, 12" VALVES WITH 4 ALL-THREAD RODS.
- ROD DIAMETER SHALL BE EQUAL TO THAT OF THE GLAND BOLTS. RODS SHALL BE GIVEN ONE COAT OF BITUMASTIC PAINT.





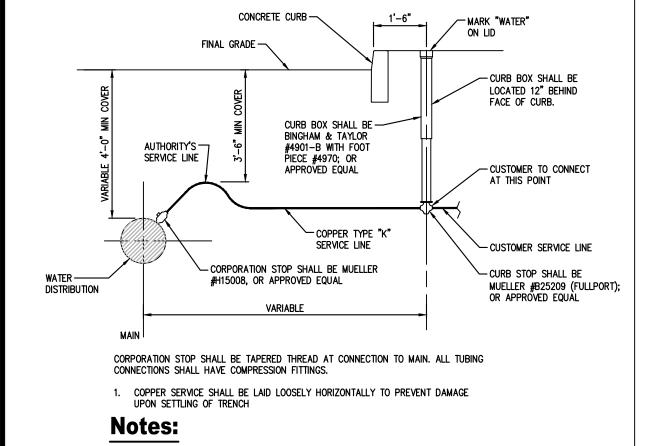
NOT TO SCALE



**Typical Sanitary Sewer** Lateral Connection

JOSEPH E. RENTKO, P.E. #PE085609 2455 BLACK FOREST DRIVE COPLAY, PA 18037 570-239-4499


SEAL:



- 1. ALL PIPE MUST BE BEDDED IN A MIN. 4" LAYER OF SAND OR SCREENINGS AND SHALL BE BACK FILLED WITH THE SAME MATERIAL IN MAX. 6" LAYERS COMPACTED. EACH LAYER SHALL BE HAND TAMPED UNTIL 1' OF COVER EXISTS OVER THE PIPE.
- PIPES AROUND WIRES AND ALL PLUGS, CAPS, HYDRANTS, TEES, CROSSES, VALVES, ETC., SHALL BE BLOCKED WITH CONCRETE TO TAKE THE REACTION AND OR THRUST.

### **Water Lateral Small Service Connection**

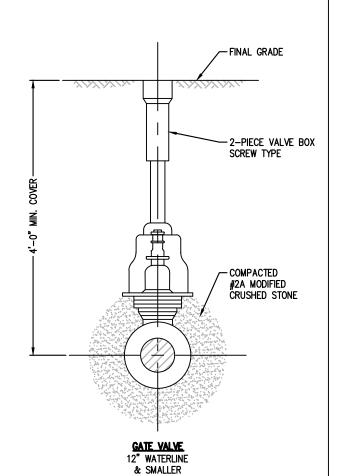NOT TO SCALE




### **Gate Valve Detail**


NOT TO SCALE


# NOTE:

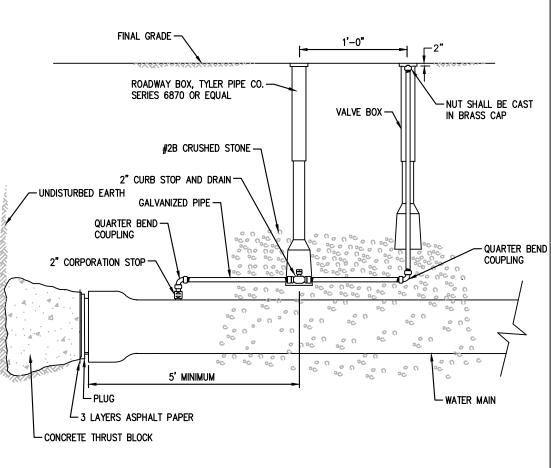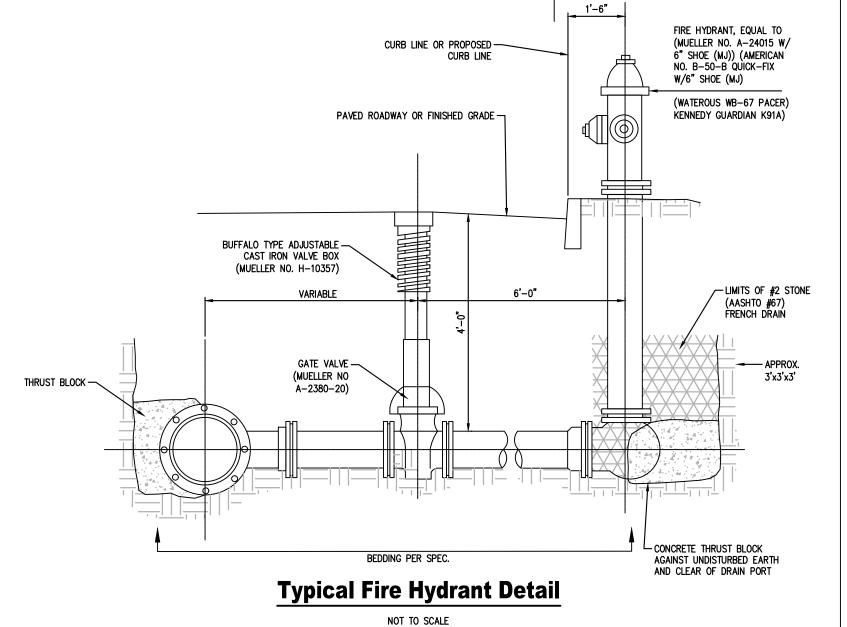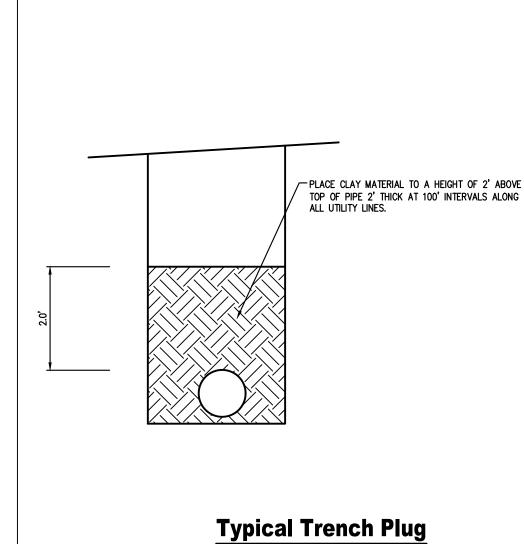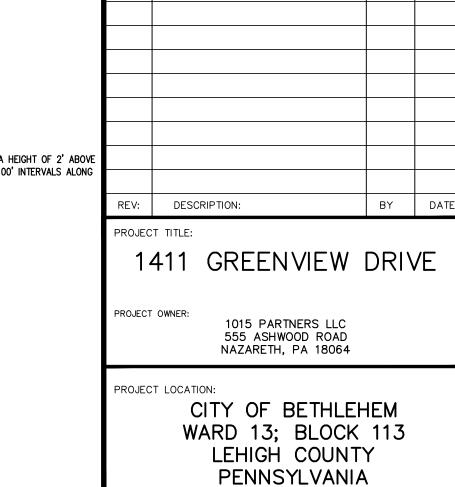
- 1. RETAINER GLANDS REQUIRED ON ALL MECHANICAL JOINT FITTINGS
- 2. ROD DIAMETER SHALL BE EQUAL TO THAT OF THE GLAND BOLTS. RODS SHALL BE GIVEN ONE COAT OF BITUMASTIC PAINT.














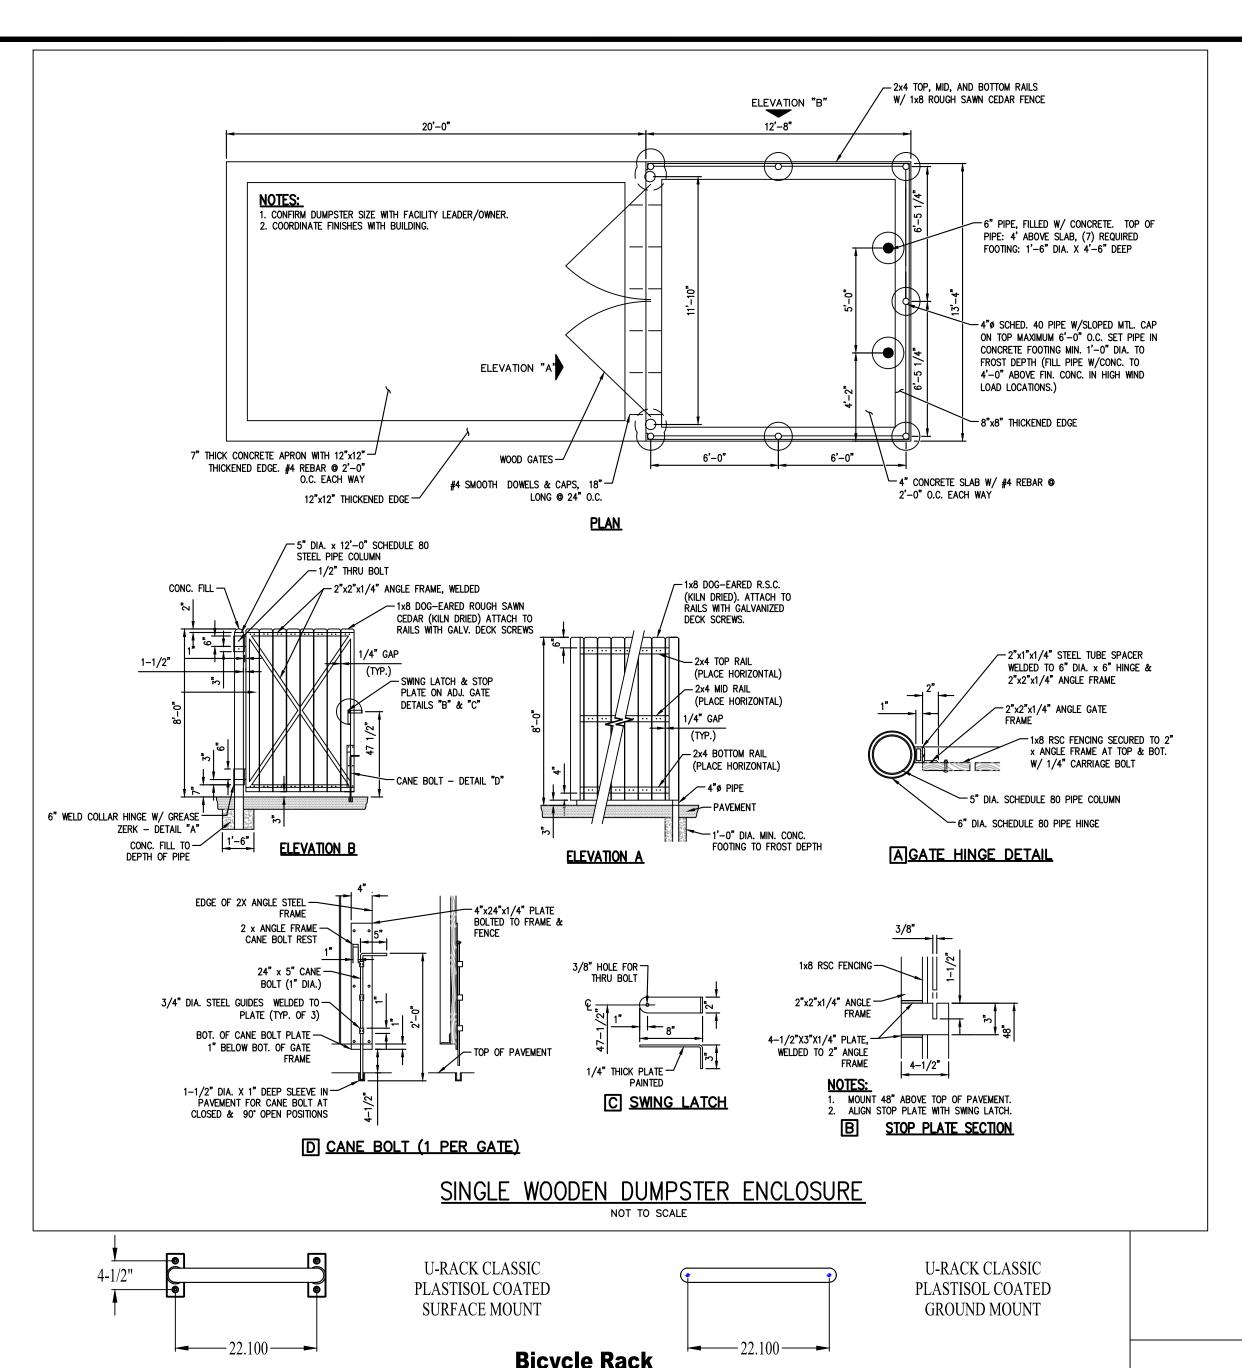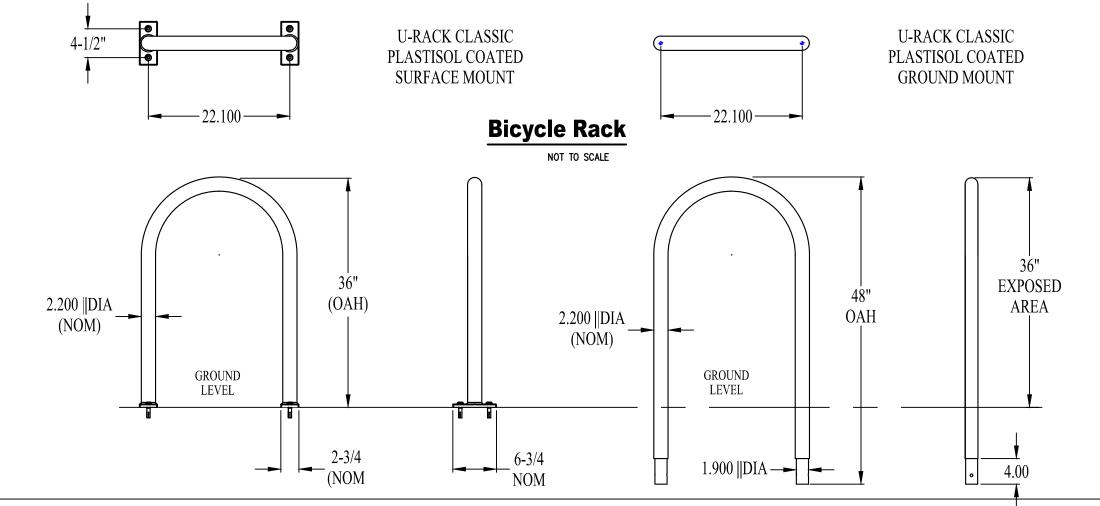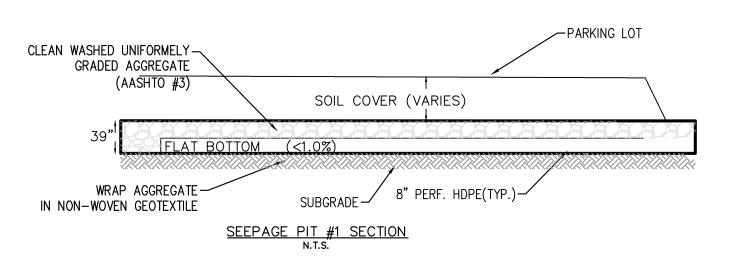
CONSTRUCTION DETAILS CHECKED: SCALE: DRAWN: 9/5/23 JER JER AS NOTED ROJECT NO. DRAWING NO. REVISION:







BMP #	BED SLOPE %	AREA (SF)	BOTTOM OF STONE	TOP OF STONE	DESIGN INFIL. RATE (IPH)	FIELD INFIL. RATE (IPH)	SPILLWAY
1	0	5500	356.00	358.00	2	4	360.18

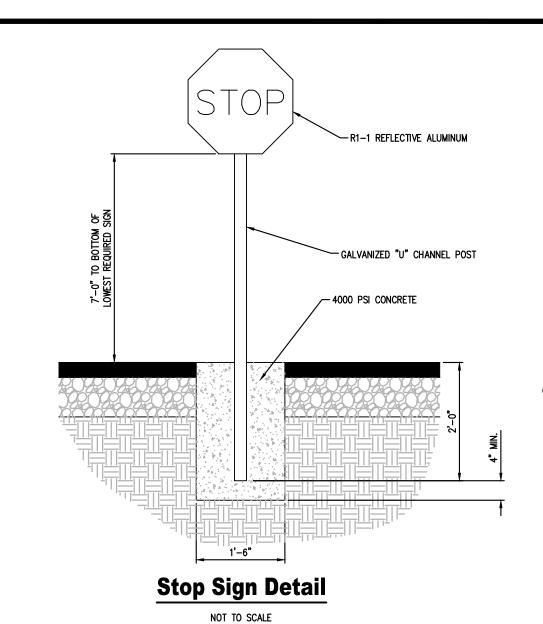

VIOLATORS

SUBJECT TO FINE

AND TOWING

MIN.FINE \$50

MAX.FINE \$200


R7-8F

12"X18"

12"X6" R7-8B

**Parking Signs** 

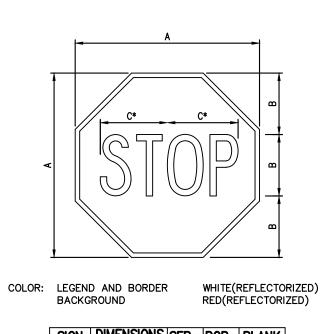NOT TO SCALE



24X24 | 30 | 10 | 12.5 | C | 3/4 | BI-30 SIGNAGE

MESSAGE SIZE QTY. SERIES | STOP SIGN 30X30 (HIGH INTENSITY SIGNS REQUIRED)

A B C D E F G H J K L M

12x18 12 18 2 1 11/2 21/2 6 47/8 5 41/4 3 1/2

COLOR: LEGEND AND BORDER GREEN (NON-REFLECTORIZED)

"Reserved Parking" Sign PennDOT R7-8

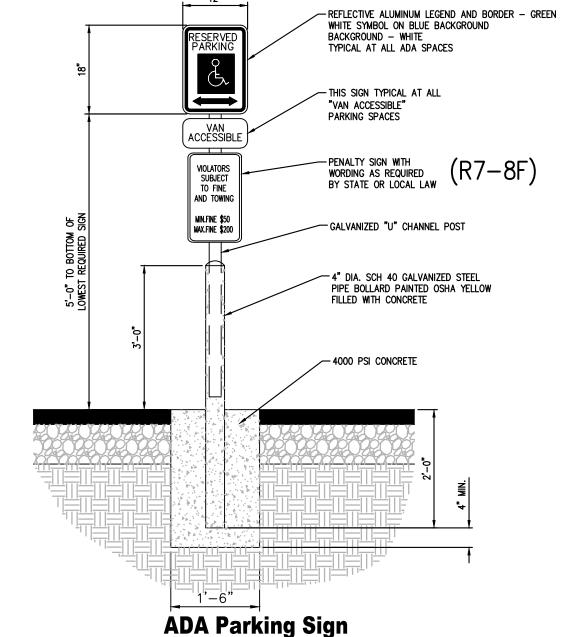
NOT TO SCALE

WHITE (NON-REFLECTORIZED)

WHITE (NON-REFLECTORIZED) BLUE (NON-REFLECTORIZED)

BACKGROUND


BACKGROUND





- MOUNT ALL SIGNS ON PENNDOT STD. 2.25 LB. BREAKAWAY CHANNEL BAR POSTS, UNLESS NOTED OTHERWISE.

NOTE: ONE AT EACH ADA SPACE. WHERE ADA SPACES FACE EACH OTHER WITHOUT WALKWAY, THERE SHALL BE ONE POST WITH SIGNS MOUNTED BOTH SIDES.

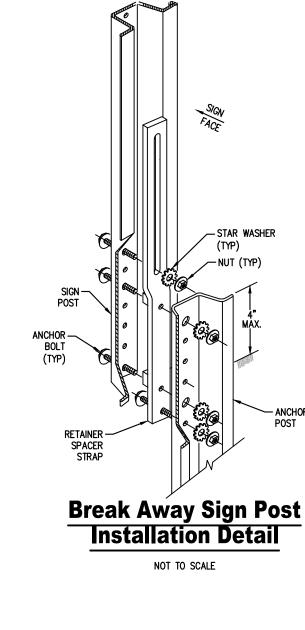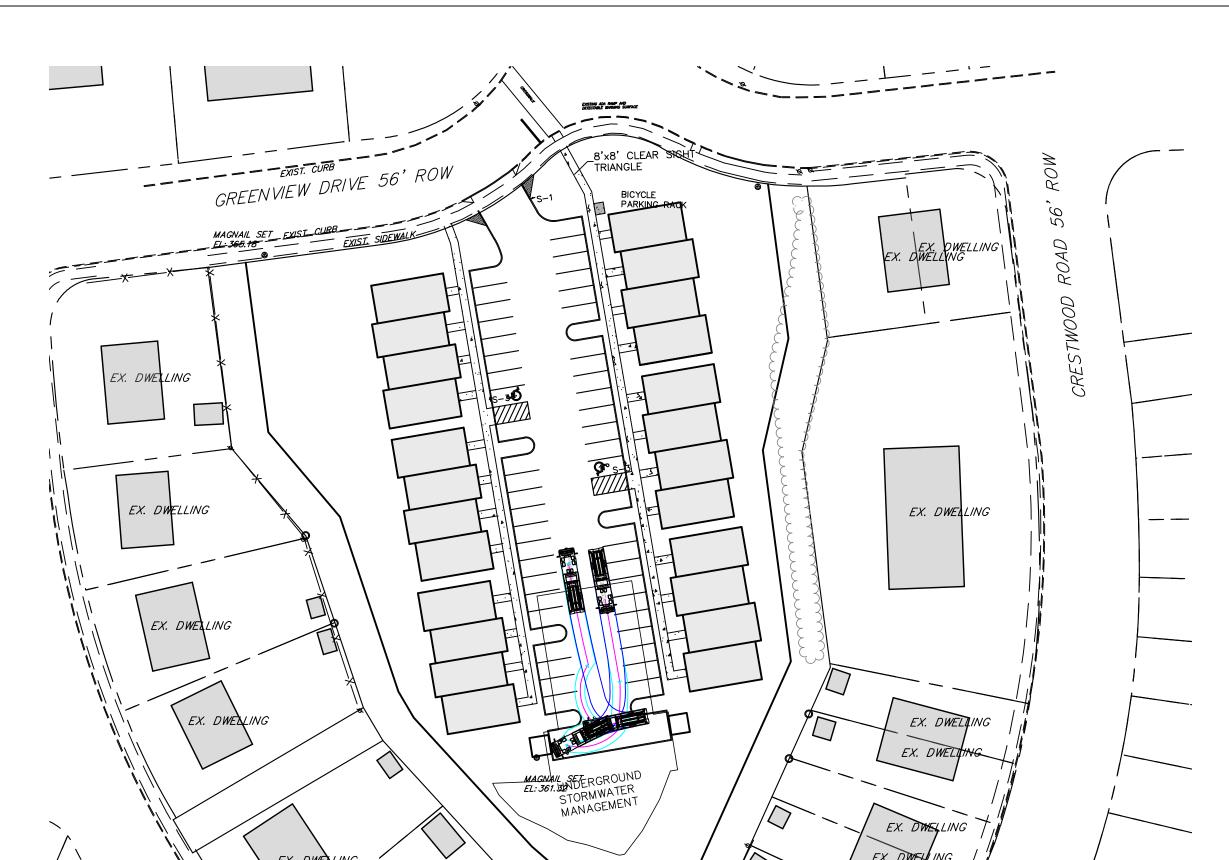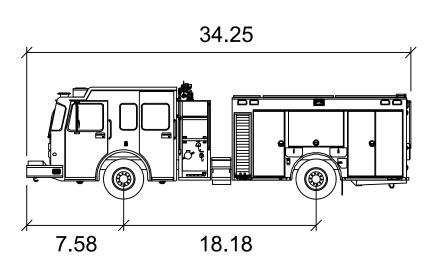- MARK ALL PARKING SPACES WITH 4" WIDE SOLID WHITE LINES.








# NFD Pumper Pierce Enforcer


Feet Width : 8.53 Track : 8.01 : 6.0 s Lock to Lock Time : 50.0 deg Steering Angle

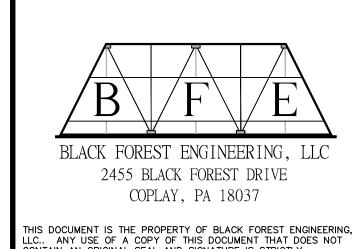**EMERGENCY VEHICLE TURNING MOVEMENT** 50 SCALE



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SEAL:

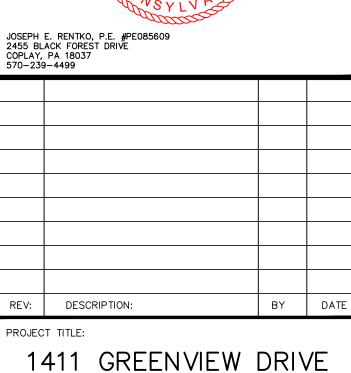

PROJECT OWNER:

1015 PARTNERS LLC 555 ASHWOOD ROAD NAZARETH, PA 18064

PROJECT LOCATION: CITY OF BETHLEHEM WARD 13; BLOCK 113 LEHIGH COUNTY PENNSYLVANIA

RIGHTS-OF-WAY DEDICATION										
SCALE:	DATE:	DRAWN:	CHECKED:							
AS NOTED	9/5/23	JER	JER							

REVISION: DRAWING NO.