

#### <u>REQUIRED NOTES ON SITE PLANS – 7/20/2010</u>

STORM WATER MANAGEMENT REGULATIONS (ARTICLE 925)

This project, under the provisions of Article 925.06, is exempt from the requirements of the stormwater management Ordinance because the area of proposed new impervious surface is less than 10,000 square feet,

except as cited in Section 925,06C and D. To comply with Section 925.06 C and D, this plan incorporates provisions for dispersing the storm runoff from roof

gutter and downspouts between adjacent Moravia Street and Benner Avenue. The downspouts will be discharged on grade and allowed to run across planting bed and lawn areas prior to discharging into the street gutters and existing storm drainage inlets and pipes within the existing City of Bethlehem public streets.

In order to maintain continuity between plan revisions, any changes to a previous plan submission shall be flagged with a triangle. Any changes not flagged may be considered not approved. Flagged changes shall be referenced to the appropriate revision date in the revision block.

Accurate as-built plans shall be kept up to date during the construction process. At the completion of the project record drawings shall be developed from the as-built plans and submitted to the City Engineer's Office. All final drawings shall show North American Datum (NAD) 1983 State Plane Coordinates in feet (Pennsylvania South, FIPS Zone 3702) and the digital file shall be in State Plane Feet Coordinates as applicable. The hard copy of the record drawings shall be in the form of a Mylar copy. The landscape architect of record shall certify (i.e. L.A. stamped and signed) that the record drawings comply substantially with the approved plan and that they conform to industry standards. All digital files shall reside on PC compatible CD Rom containing the digital representation of the final plan as presented on the twenty-four (24) inch by thirty-six (36) inch sheets. The digital map shall be AutoCAD compatible. All layers included in the digital maps shall be the standardized layers prepared and utilized by the City of Bethlehem to ensure compatibility with the City's existing CAD standards and as described in Appendix A of the City's Subdivision and Land Development Ordinance.

<u>ENGINEERING PERMITS NOTE</u>
Prior to any work within the Right-of-Way, permits must be obtained from City Engineering Office.

Detail of retaining wall is required. A note shall be added to the plan stating the design and details of the retaining walls, certified by an Engineer experienced in the design of retaining walls and licensed in the State of Pennsylvania, will be submitted to the City for review and approval. The proposed retaining wall is 8 feet in length and retains a maximum of 3.3 feet of grade differential, and therefore detailed engineering is not required. The wall will be a standard block wall, installed and reinforced per the manufacturer's recommendations.

#### MISCELLANEOUS INFORMATION/ DESIGN STANDARDS

SANITARY SEWER LOCATION DESIGN STANDARD North & South = 5' West of centerline East & West = 5' South of centerline (Per J. Mari 7-5-06)

ROAD CONSTRUCTION OR OVERLAY

Super pave is required and must meet Penn DOT specifications Pub.408 (Per L. Mika 10-5-05)

IMPERVIOUS SURFACE FEE

If on-lot detention no fee is charged. Impervious surfaces – additions, decks, patios, garages, driveways, sheds, similar structures, roof, parking areas, driveways areas, new streets, new sidewalk. <u>EXEMPT</u> – existing gravel crushed stone, hard packed soil.

Square feet of new impervious surface x = 0.1 = 5 cost only if no detention is proposed.

Note that the LVPC reviews <u>all</u> site plans that it is required to sign prior to being recorded in the courthouse of either Northampton or Lehigh County, regardless of the size of the site or the net amount of impervious surfaces. The LVPC is not required to review a Storm Water Management Plan for a site that does not result in an increase of 10,000 square feet of impervious surfaces. (Per S. W. DeSalva 09-19-06)

**EROSION & SEDIMENTATION CONTROL PLAN** 

A plan is required for earth disturbance activity of 5,000 square feet or more. City requires County Conservation (LCCD or NCCD) review of 1 acre (43,560 square feet) or more. This site area is a total of 0.25 acres and therefore is exempt from the requirement for LCCD or NCCD review.

In accordance with Orcinance No. 4342, at the time of a request for a building permit or at the execution of the developer's agreement, a sanitary sewer tapping fee of \$2,527 per EDU will need to be paid. The total amount will be determined when a sanitary sewer facilities planning module application is submitted. Please include a cover letter describing the project in the planning module submittal.

SITE DATA: SITE ADDRESS: 968 BENNER AVENUE, CITY OF BETHLEHEM, PA 18015 PARCEL ID: P6SW3D 4 5 CITY WARD & BLOCK WARD 1, BLOCK 21B ALLAN & NANCY A. FINNEGAN OWNER/ APPLICANT 220 WEST BROAD STREET BETHLEHEM, PA 18018

610-597-9383

BK 737, PG 921

DEED REF.:

ZONING DATA: RT - HIGH DENSITY RESIDENTIAL DISTRICT

<u>REQUIRED</u> <u>PROVIDED</u> MINIMUM LOT AREA: 9,000 SF. 10,919 SF. MINIMUM YARD REQUIREMENTS: FRONT: SIDE (ONE): SIDE (TOTAL): 3.5 Stories/35' 3.5 Stories/35' MAXIMUM BUILDING HEIGHT: MAXIMUM BUILDING COVERAGE: 30 % 12.81%

NONE %

32.9% (3,595 SF.)

SHEET NUMBER

SP-1

DATE

6/19/2019

PARKING DATA:

REQUIRED SPACES

Z.O. Sect. 1319.01(a)(1)(II) - Residences / Apartments.... 2.00 SPACES PER DWELING UNIT FOR 3 BEDROOMS

PROVIDED SPACES 3 TYPE A UNITS PROPOSED


 $3 \times 2.00 = 6 \text{ SPACES}$ 

NOTE REGARDING PROPOSED BUILDING FACADE MATERIALS
THESE MATERIALS ARE AS SHOWN ON THE PLANS PREPARED

BY PORTNER AND HETKE ARCHITECTS:

BUILDING FACADES FACING STREETS AND SIDES WILL BE STUCCO OVER A CULTURED STONE FACED WATERTABLE, THE REAR FACING FACADES WILL BE VINYL SIDING. BUILDING ROOFS WILL BE ASPHALT SHINGLED.

### PLAN LEGEND:

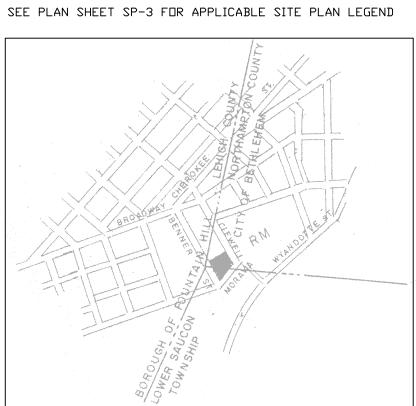

LOCATION MAP:

#### CERTIFICATION OF OWNERSHIP

I (we) the owner(s) of , being duly sworn according to law, depose and say that I (we) am (are) the sole owner(s) of the above property in peaceful possession of the same and that there are no suits or liens pending affecting the title thereof.

> Signature of Owner Signature of Owner

Sworn and subscribed to before me this \_\_\_\_\_ day of \_\_\_\_\_

walkways, and other structures and improvements shown thereon.

My Commission expires on \_\_\_\_\_


ENGINEER'S OR SURVEYOR'S CERTIFICATION I hereby certify that this plan correctly and accurately represents the lands of the owner and, where applicable, the lots, buildings, streets, parking areas,

Xevin E. Hodorawis Registered Engineer or Surveyor Registration No. SU075414



LANDSCAPE ARCHITECT'S CERTIFICATION I hereby certify that this plan correctly and accurately represents the lands of the owner and, where applicable, the lots, buildings, streets, parking areas, walkways, and other structures and improvements shown thereon.

Registered Landscape Architect Registration No

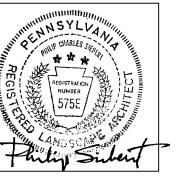

LEHIGH VALLEY PLANNING COMMISSION: REVIEWED BY THE LEHIGH VALLEY PLANNING COMMISSION, THIS \_\_\_\_\_ DAY OF \_\_\_\_\_ 20\_\_\_.

LEHIGH VALLEY PLANNING COMMISSION

CITY OF BETHLEHEM PLANNING COMMISSION:

APPROVED BY THE CITY OF BETHLEHEM PLANNING COMMISSION, THIS \_\_\_\_\_ DAY OF \_\_\_\_\_\_ 20\_\_\_.

CHAIRMAN

SECRETARY RECORDER OF DEEDS:

RECORDED THIS \_\_\_\_ DAY OF \_\_\_\_, 20\_\_, IN THE OFFICE FOR THE RECORDING OF DEEDS, etc., IN AND FOR THE COUNTY OF NORTHAMPTON, PENNSYLVANIA, IN PLAN BOOK No. \_\_\_\_\_\_,

PLAN INTENT:

THIS PLAN IS INTENDED TO DEPICT THE DEVELOPMENT OF THIS NOT CALL FOR ANY NEW ROADWAY SURFACE, THE EXTENSION OF ANY SITE UTILITIES, OR THE CREATION OF ANY NEW LOTS.

THE PLAN SHOWS THE DEVELOPMENT OF THE LOT AS A THREE (3) UNIT CONDOMINIUM ARRANGEMENT IN A TYPICAL TOWNHOUSE STYLE, WITH ALL THREE CONDOMINIUM UNITS DEVELOPED UPON A


THE PLAN LOCATES THE BUILDING WITH THE OBJECTIVE OF DISPERSING THE RUNOFF FROM NEW IMPERVIOUS SURFACES BEWEEN THE TWO (2) EXISTING STREETS, TO MINIMIZE THE IMPACT ON ANY ONE STORM DRAINAGE SYSTEM. THE PLAN ALSO SEEKS TO ADAPT TO THE EXISTING MAN-MADE STEEP SLOPES AS MUCH AS IS POSSIBLE, TO MINIMIZE THE AREA OF DISTURBANCE OF THE

THE TWO (2) HOMES FRONTING ON MORAVIA STREET ARE SITED TO ALLOW THE OFF-STREET PARKING SURFACES TO DRAIN DIRECTLY INTO THE EXISTING GUTTERS ALONG MORAVIA STREET. THE THIRD UNIT FRONTS ON BENNER AVENUE SO THAT THE UNIT ARRANGEMENT MINIMIZES THE NUMBER OF PARKING SPACES

VISIBLE ALONG THE EXISTING STREETS. THE CONDOMINIUM UNITS ARE INTENDED TO BE SOLD. THE CONDOMINIUM ASSOCIATION WILL BE RESPONSIBLE FOR THE MAINTENANCE OF THE PROPERTY.

DRAWING INDEX SHEET NUMBER SHEET TITLE RECORD PLAN - MINOR LAND DEVELOPMENT PLAN SP-1 SP-2 EXISTING CONDITIONS PLAN SP-3 GRADING AND DRAINAGE PLAN SP-3a GRADING AND DRAINAGE PLAN DETAIL SP-4 LANDSCAPE PLANTING& LIGHTING PLAN SP-5 NOTES AND DETAILS EROSION AND SEDIMENTATION CONTROL PLAN SP-6 E&S CONTROL NOTES AND DETAILS SP-7 SP-8 E&S CONTROL NOTES AND DETAILS


#### SURVEY PLAN REFERENCE: PLAN PREPARED BY N.D. REMY ASSOC, DRAWING NUMBER ANF 918-1 DATED 9-12-18 SIGNED AND SEALED BY KEVIN HODDRAWIS, PLS-REG NO, SU075414 IN PENNSYLVANIA

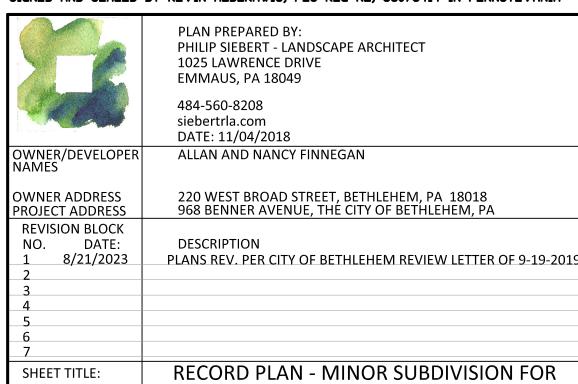



MORAVIA STREET CONDOMINIUMS


SCALE:


AS NOTED

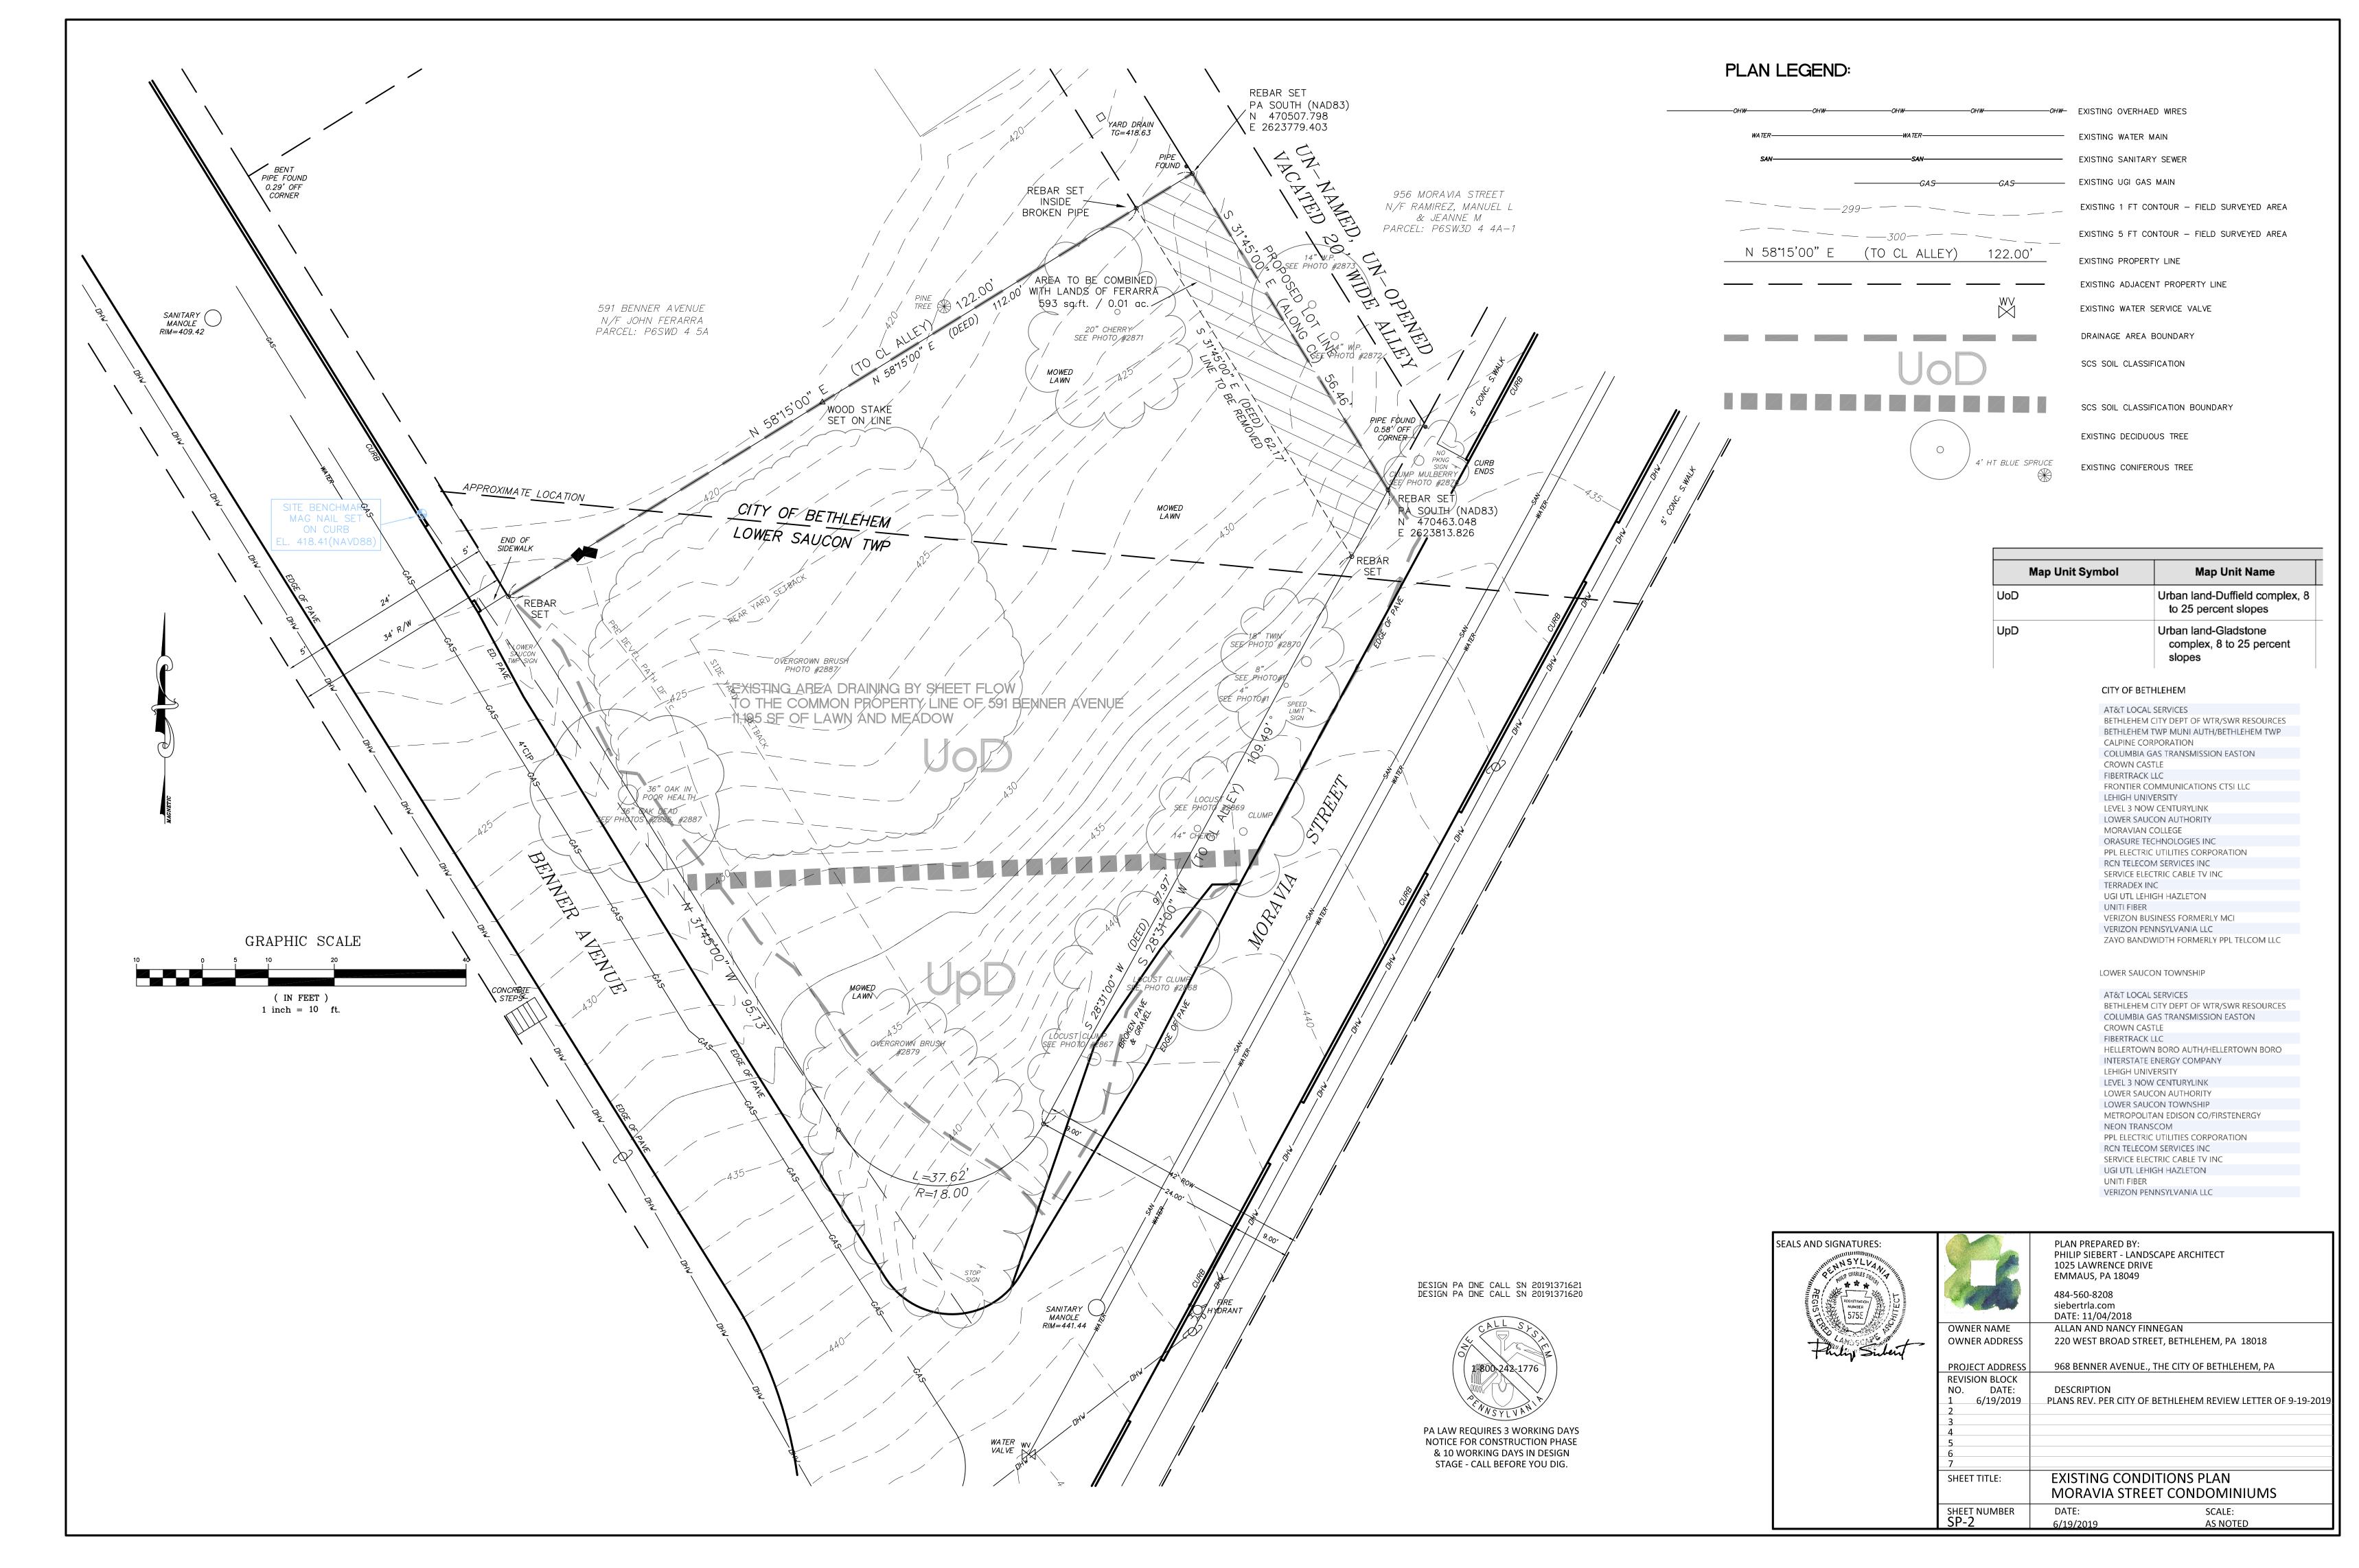

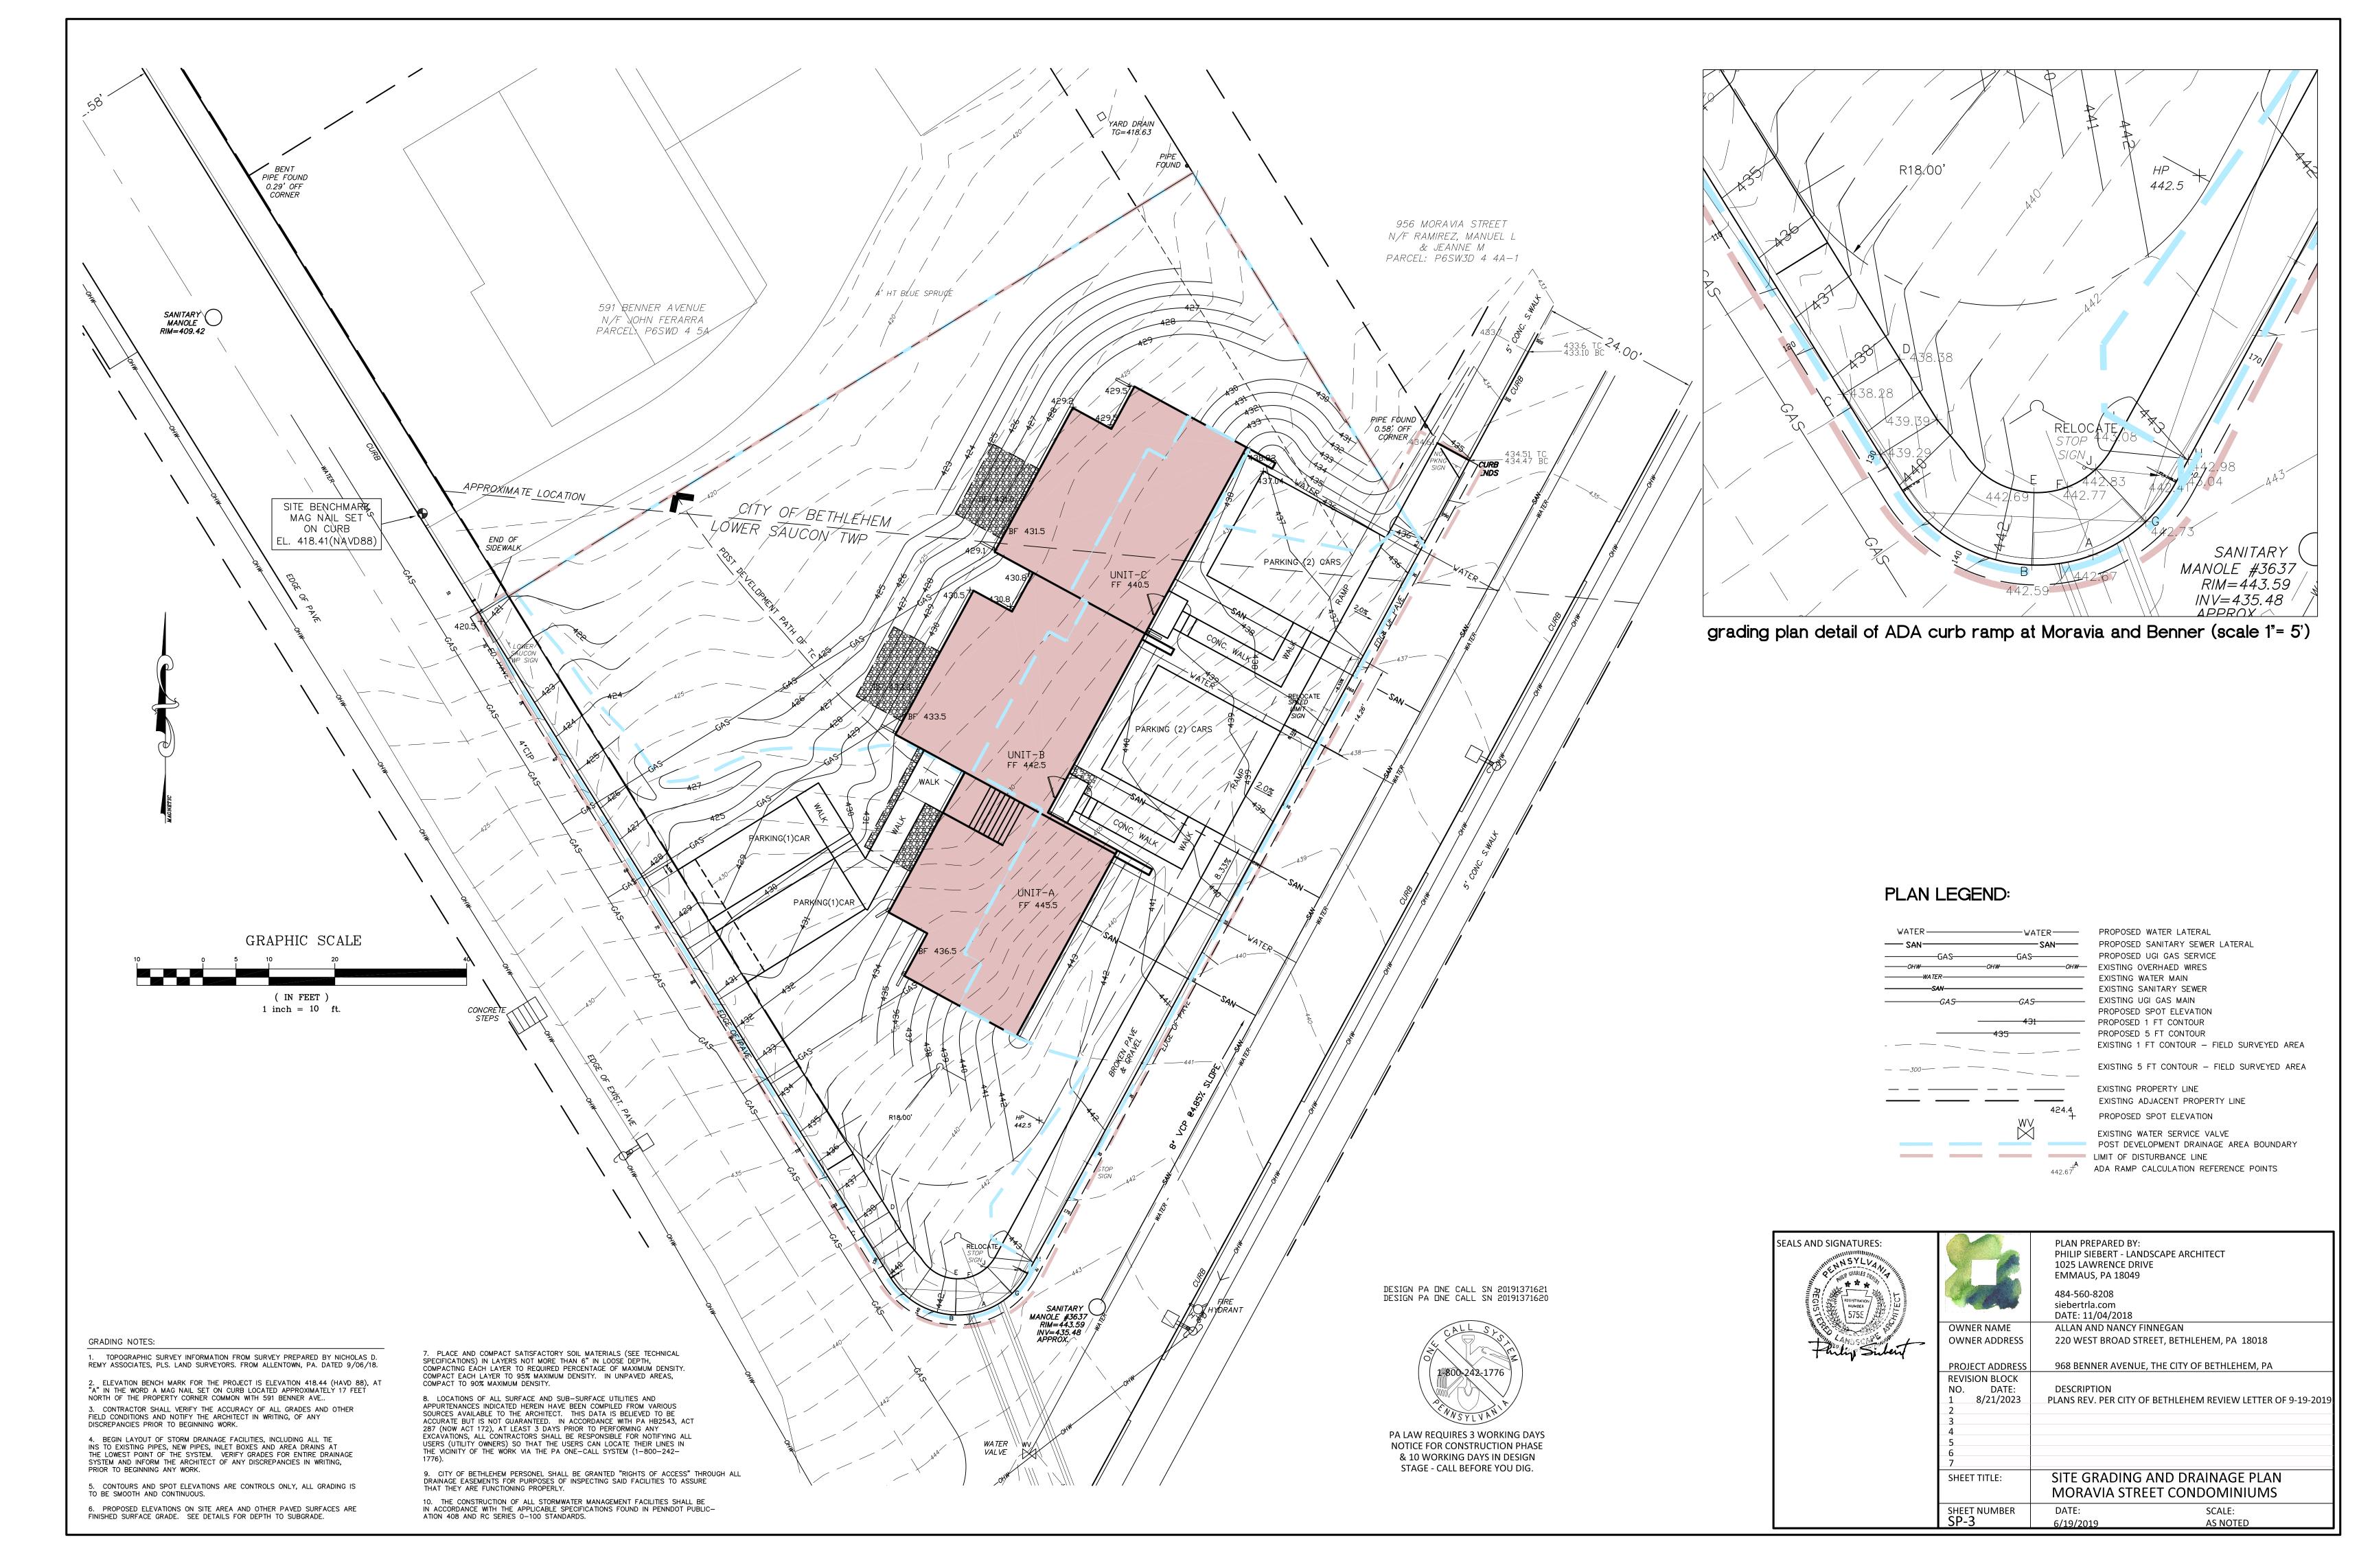


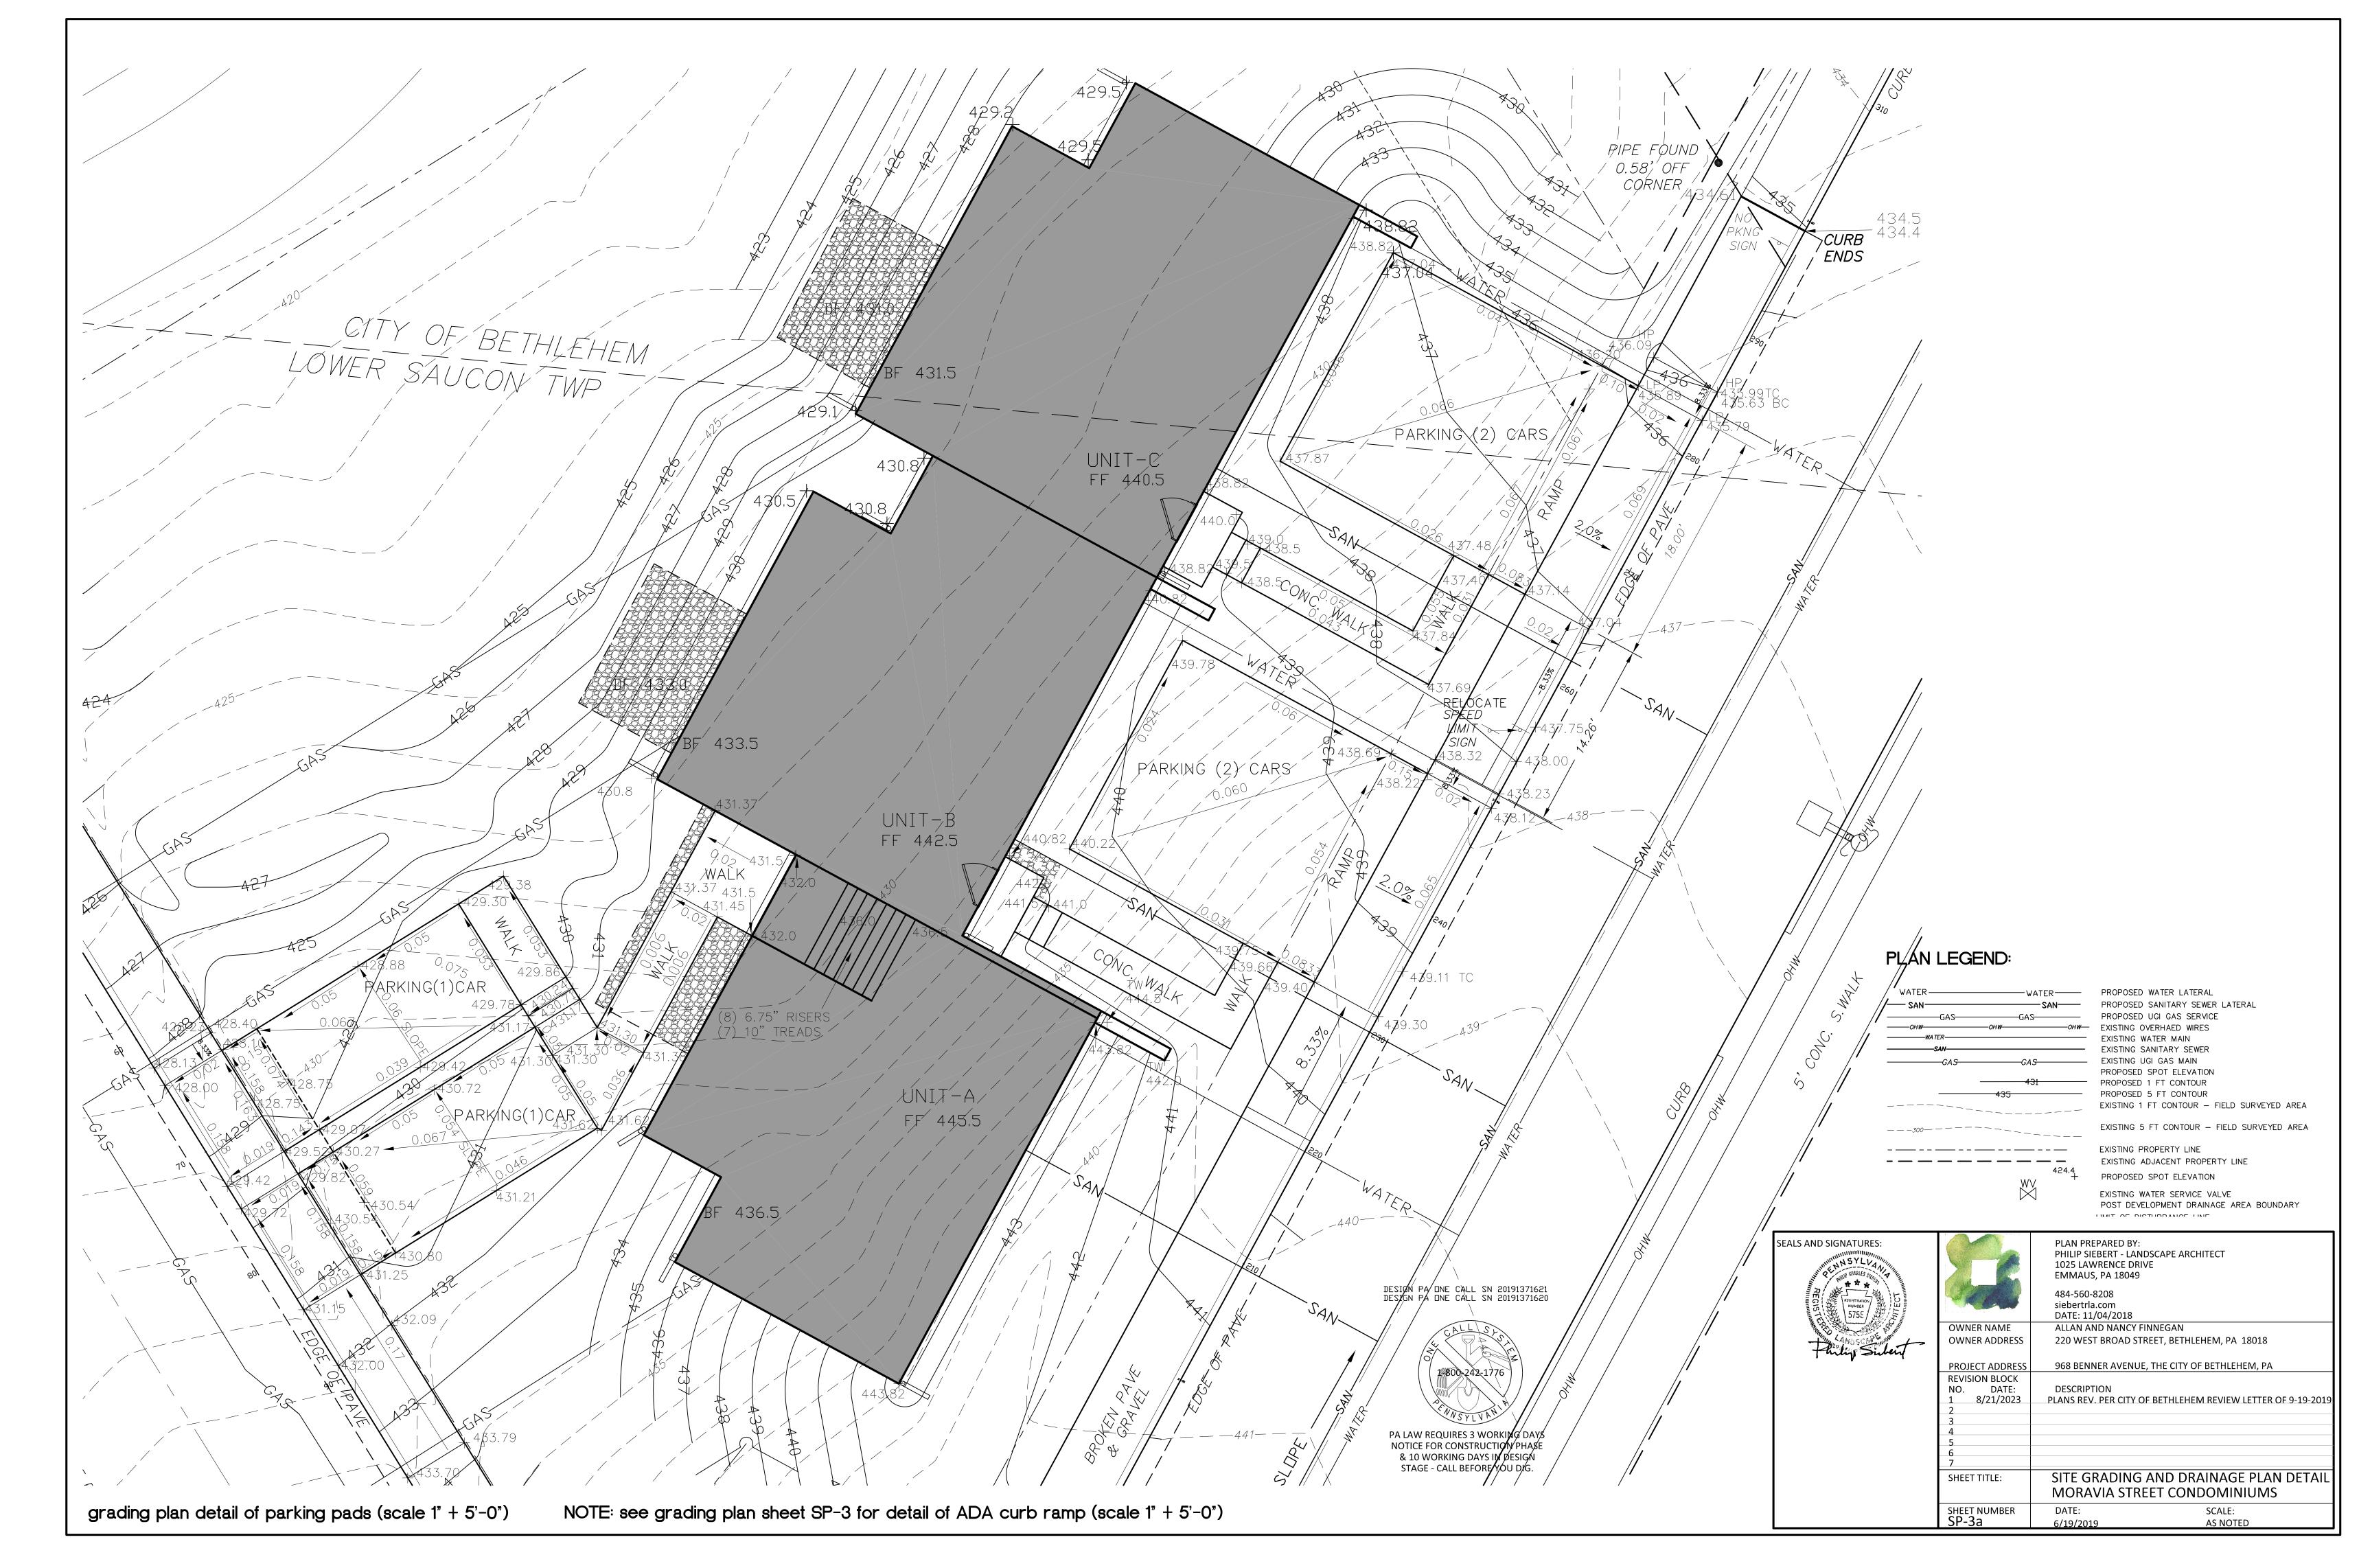


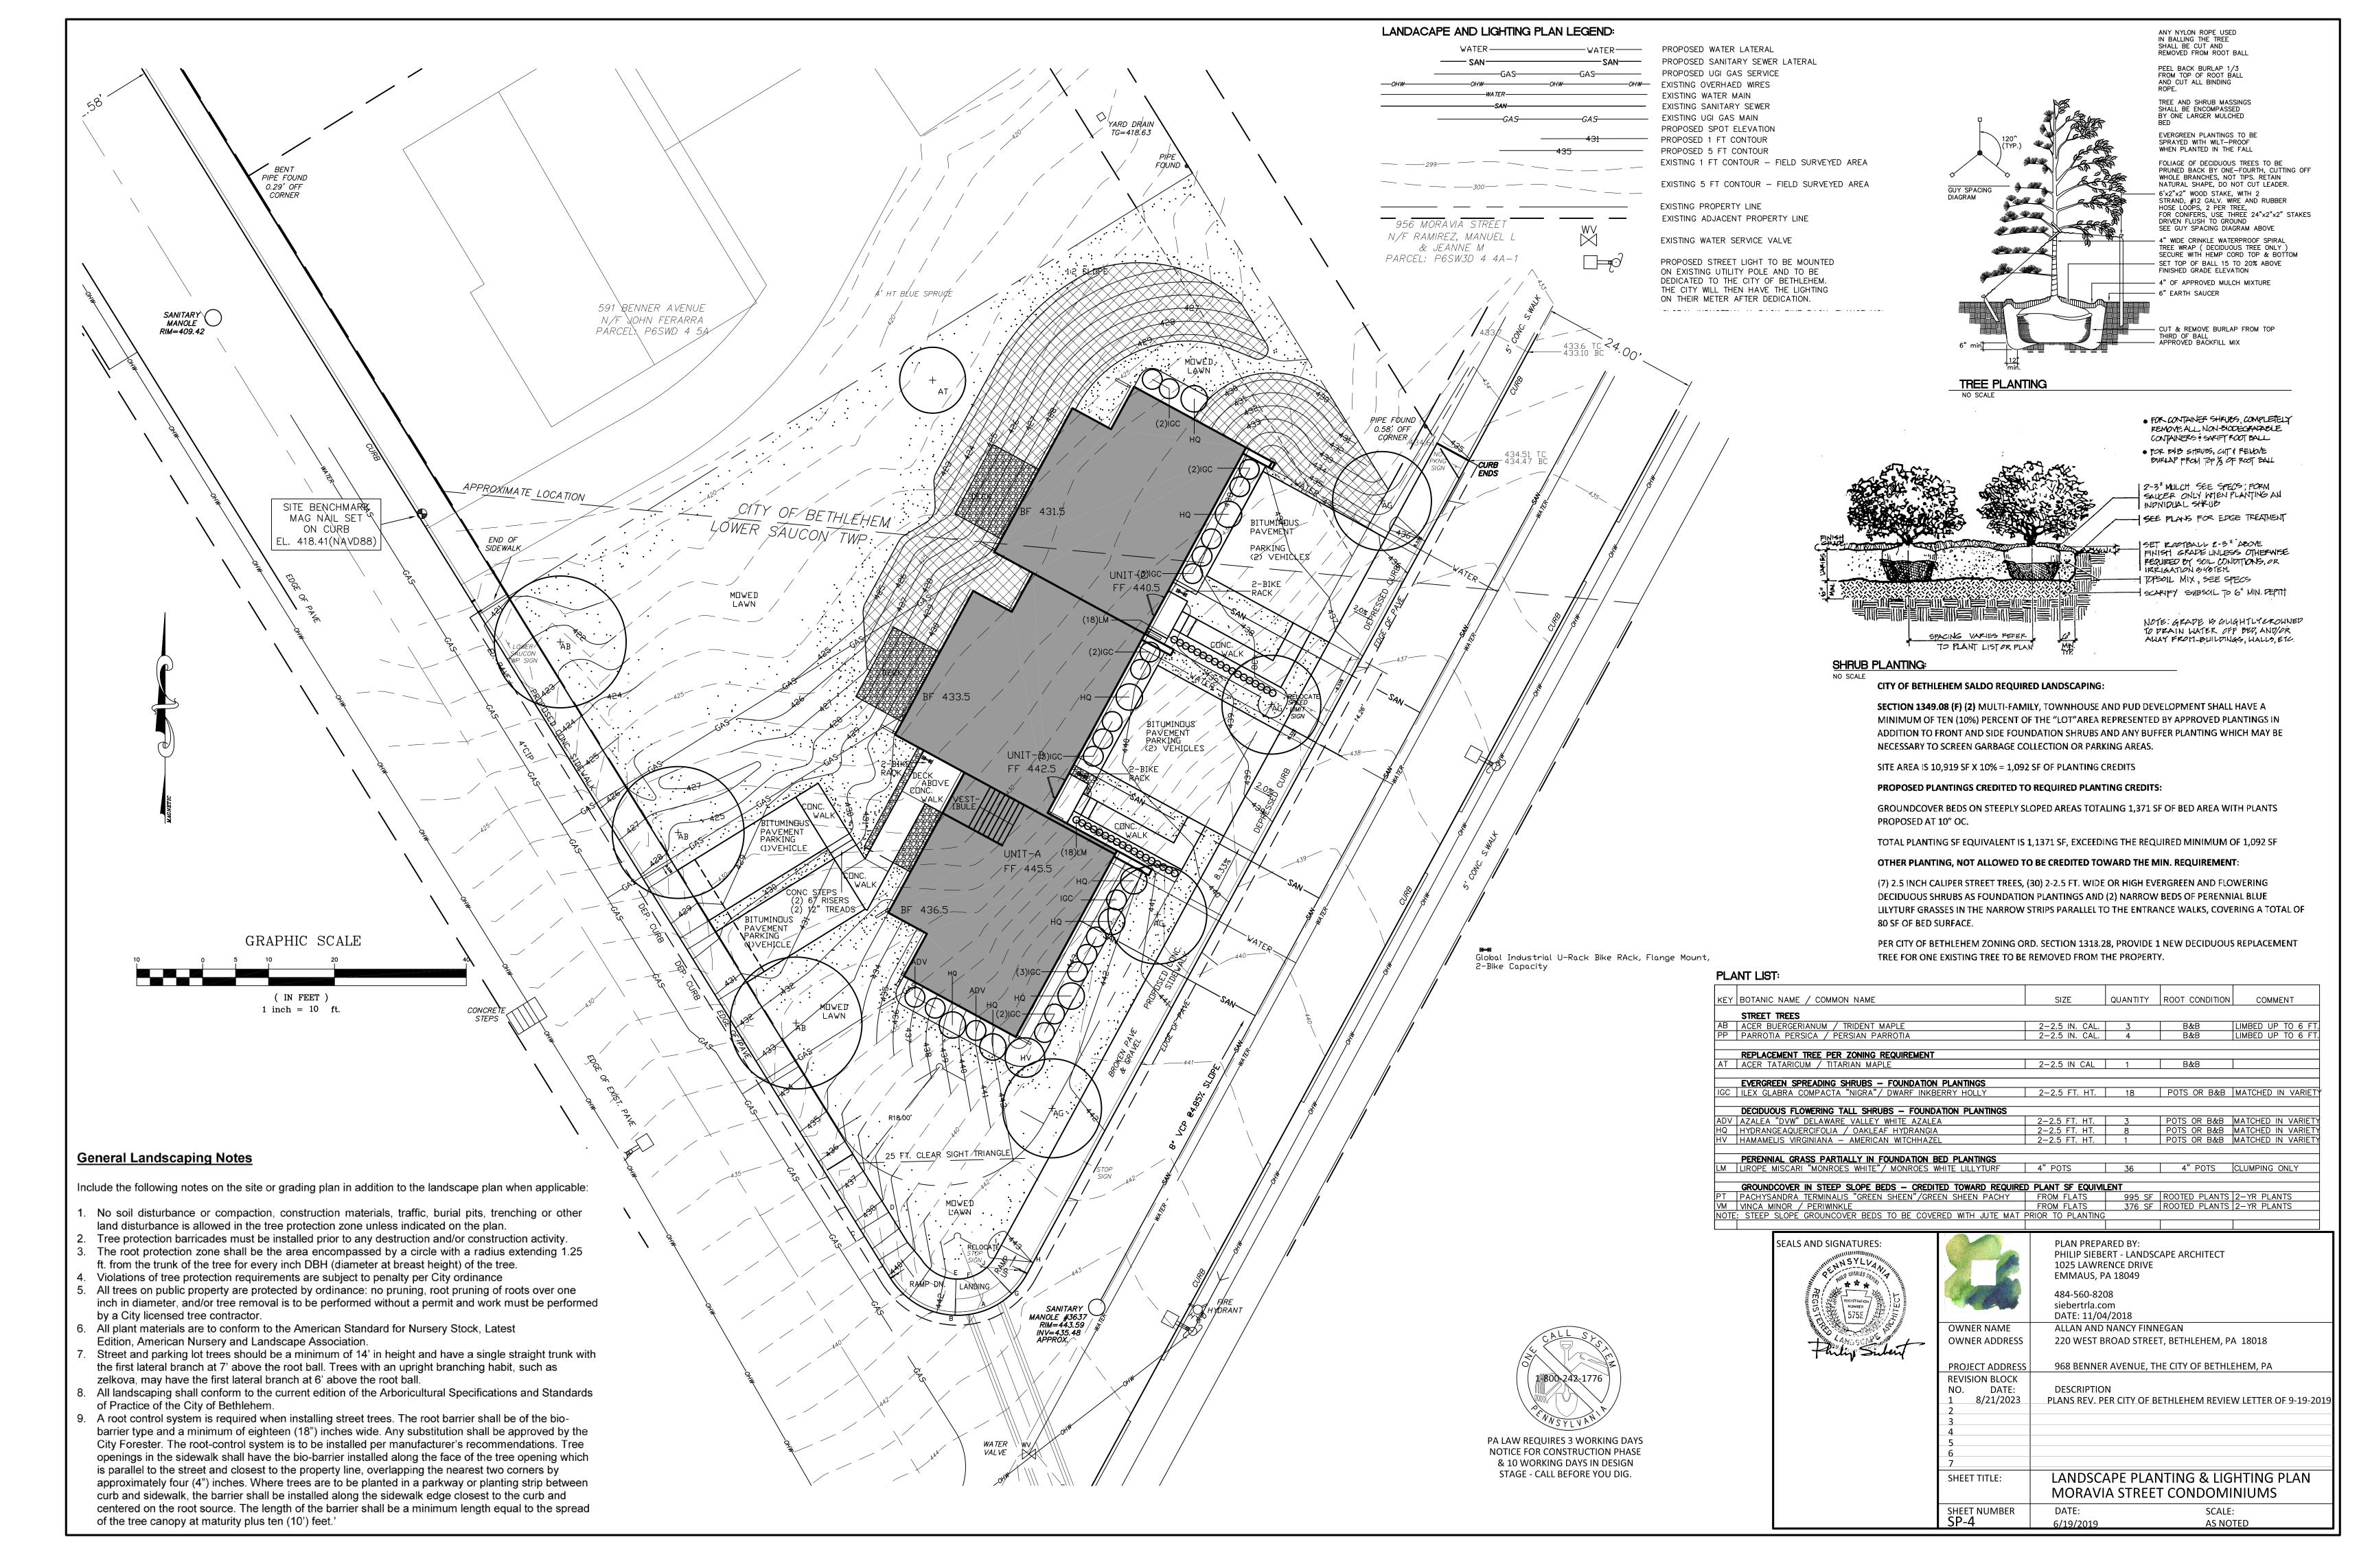

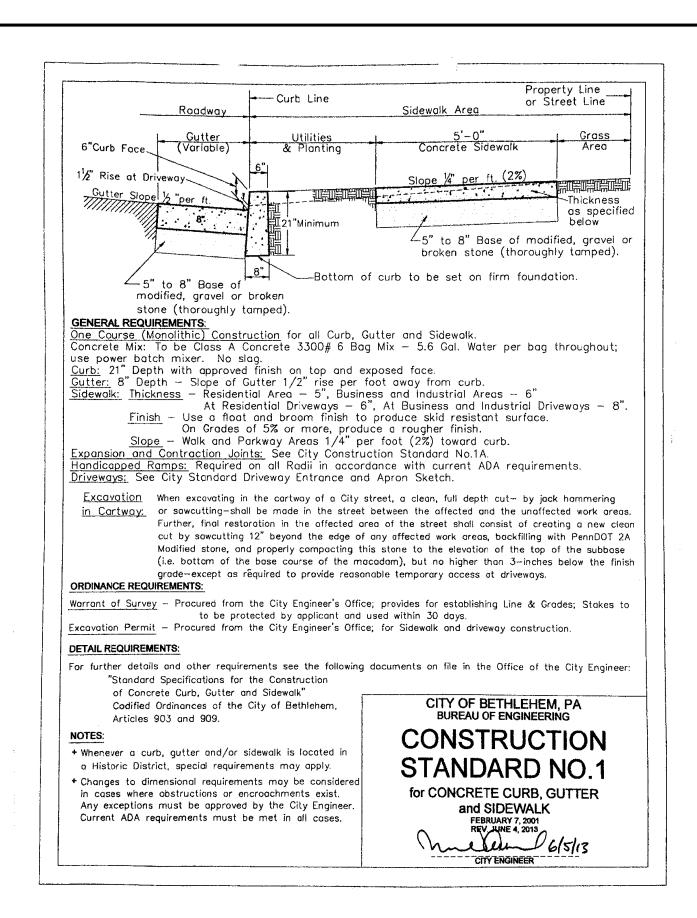




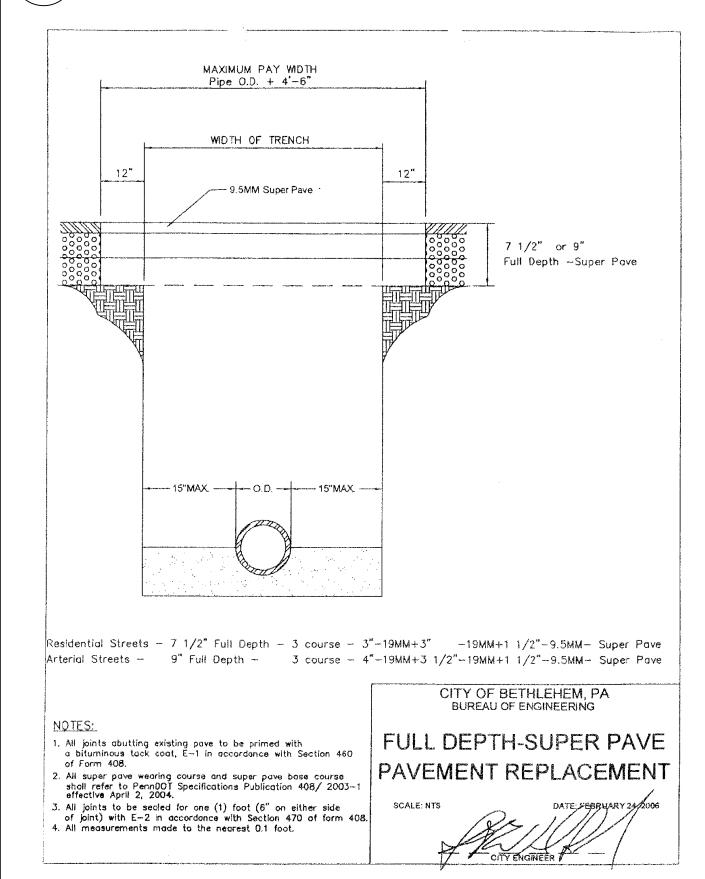

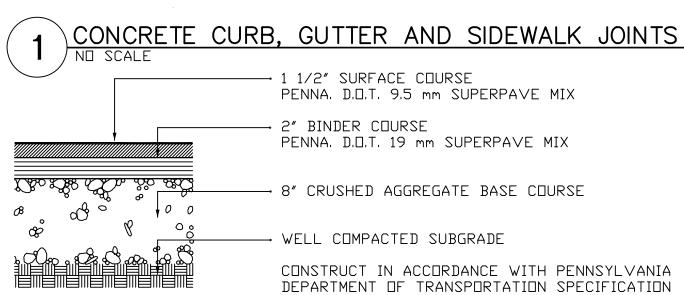


BITUMINOUS PAVING

FORM No.408, LATEST EDITION.

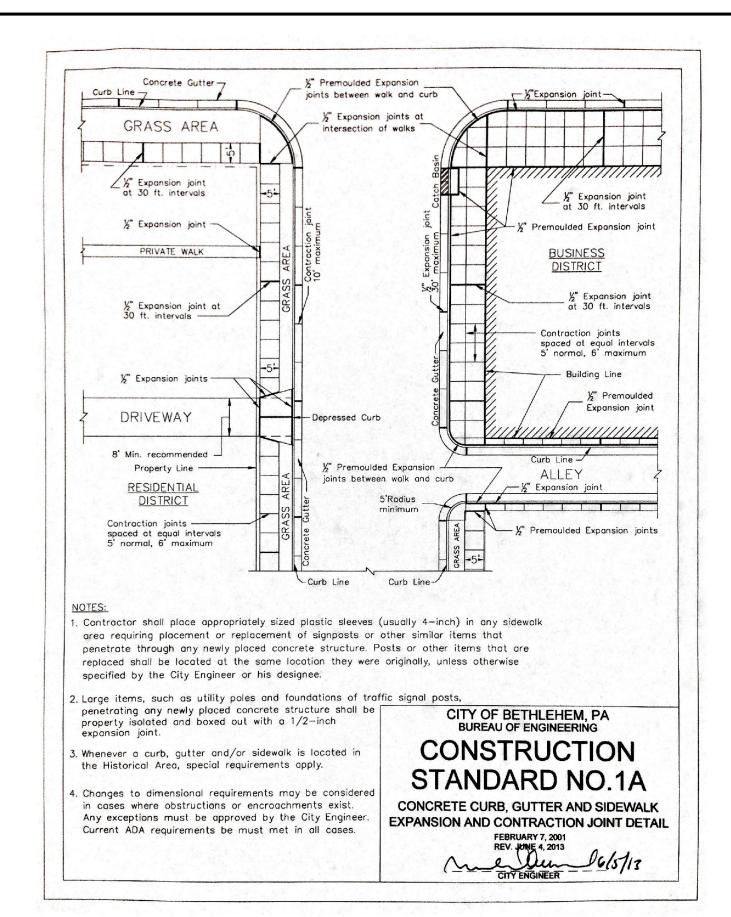



9 CONCRETE CURB, GUTTER AND SIDEWALK JOINTS

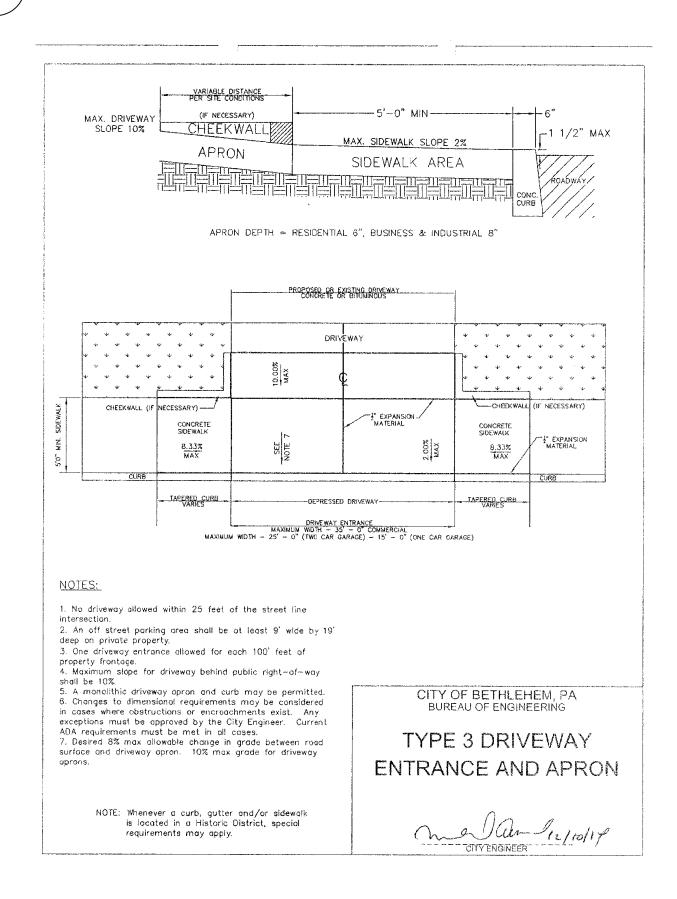


BETHLEHEM STANDARD TYPE 3 DRIVEWAY ENTRANCE AND APRON

SCALE 1" = 1'-0"

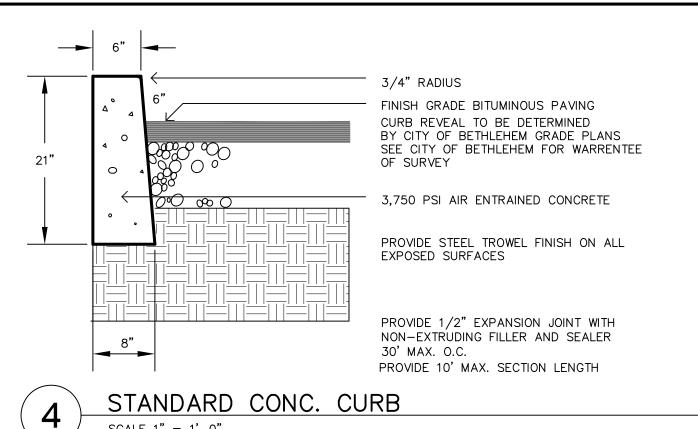


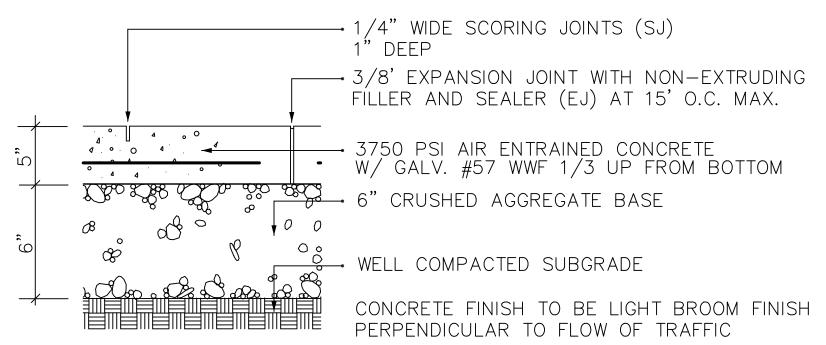




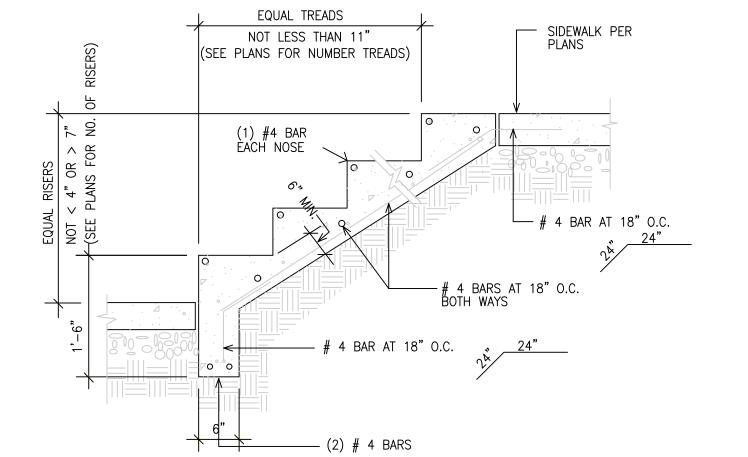

6 TYPICAL EXTERIOR CONCRETE STEPS DETAIL

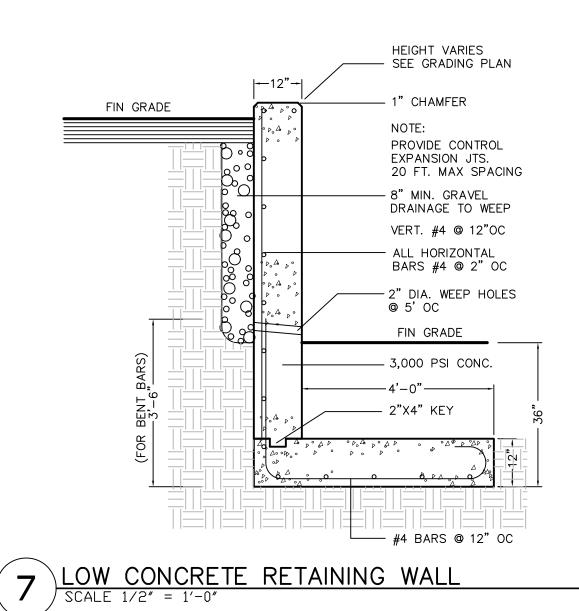

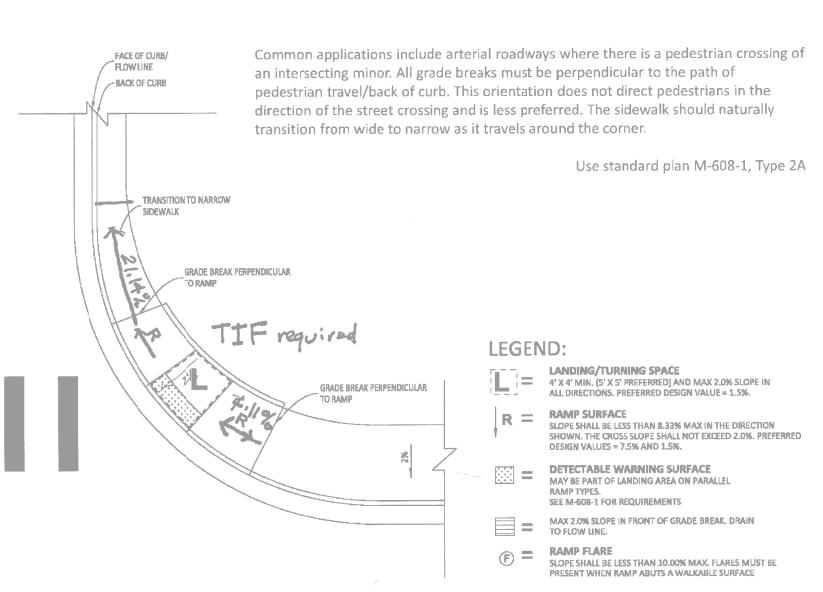

PARALLEL CURB RAMP - SINGLE RAMP ON THE APEX


## 10 ADA ACCESSIBLE CURB RAMP AT INTERSECTION

GLOBAL INDUSTRIAL U-RACK BIKE RACK, BLACK, FLANGE MOUNT, 2-BIKE CAPACITY. AS DISTRIBUTED BY GLOBAL INDUSTRIAL. MATERIAL 12-GAUGE STEEL, ITEM DIMENSIONS 14 1/2" W X 34"H ITEM MODEL NO. 442804MBK, POWDER COATED.



11 INDIVIDUAL UNIT BICYCLE RACK (2-BIKE CAPACITY)

	PLAN PREPARED BY: PHILIP SIEBERT - LANDSCAPE ARCHITECT 1025 LAWRENCE DRIVE EMMAUS, PA 18049  484-560-8208 siebertrla.com DATE: 11/04/2018
OWNER/DEVELOPER NAMES	ALLAN AND NANCY FINNEGAN
OWNER ADDRESS PROJECT ADDRESS	220 WEST BROAD STREET, BETHLEHEM, PA 18018 968 BENNER AVENUE, THE CITY OF BETHLEHEM, PA
REVISION BLOCK NO. DATE: 1 8/21/2023	DESCRIPTION PLANS REV. PER CITY OF BETHLEHEM REVIEW LETTER OF 9-19-2019.
2 3	
4 5 6	
7	
SHEET TITLE:	NOTES AND DETAILS MORAVIA STREET CONDOMINIUMS
SHEET NUMBER SP-5	DATE: SCALE: 6/19/2019 AS NOTED

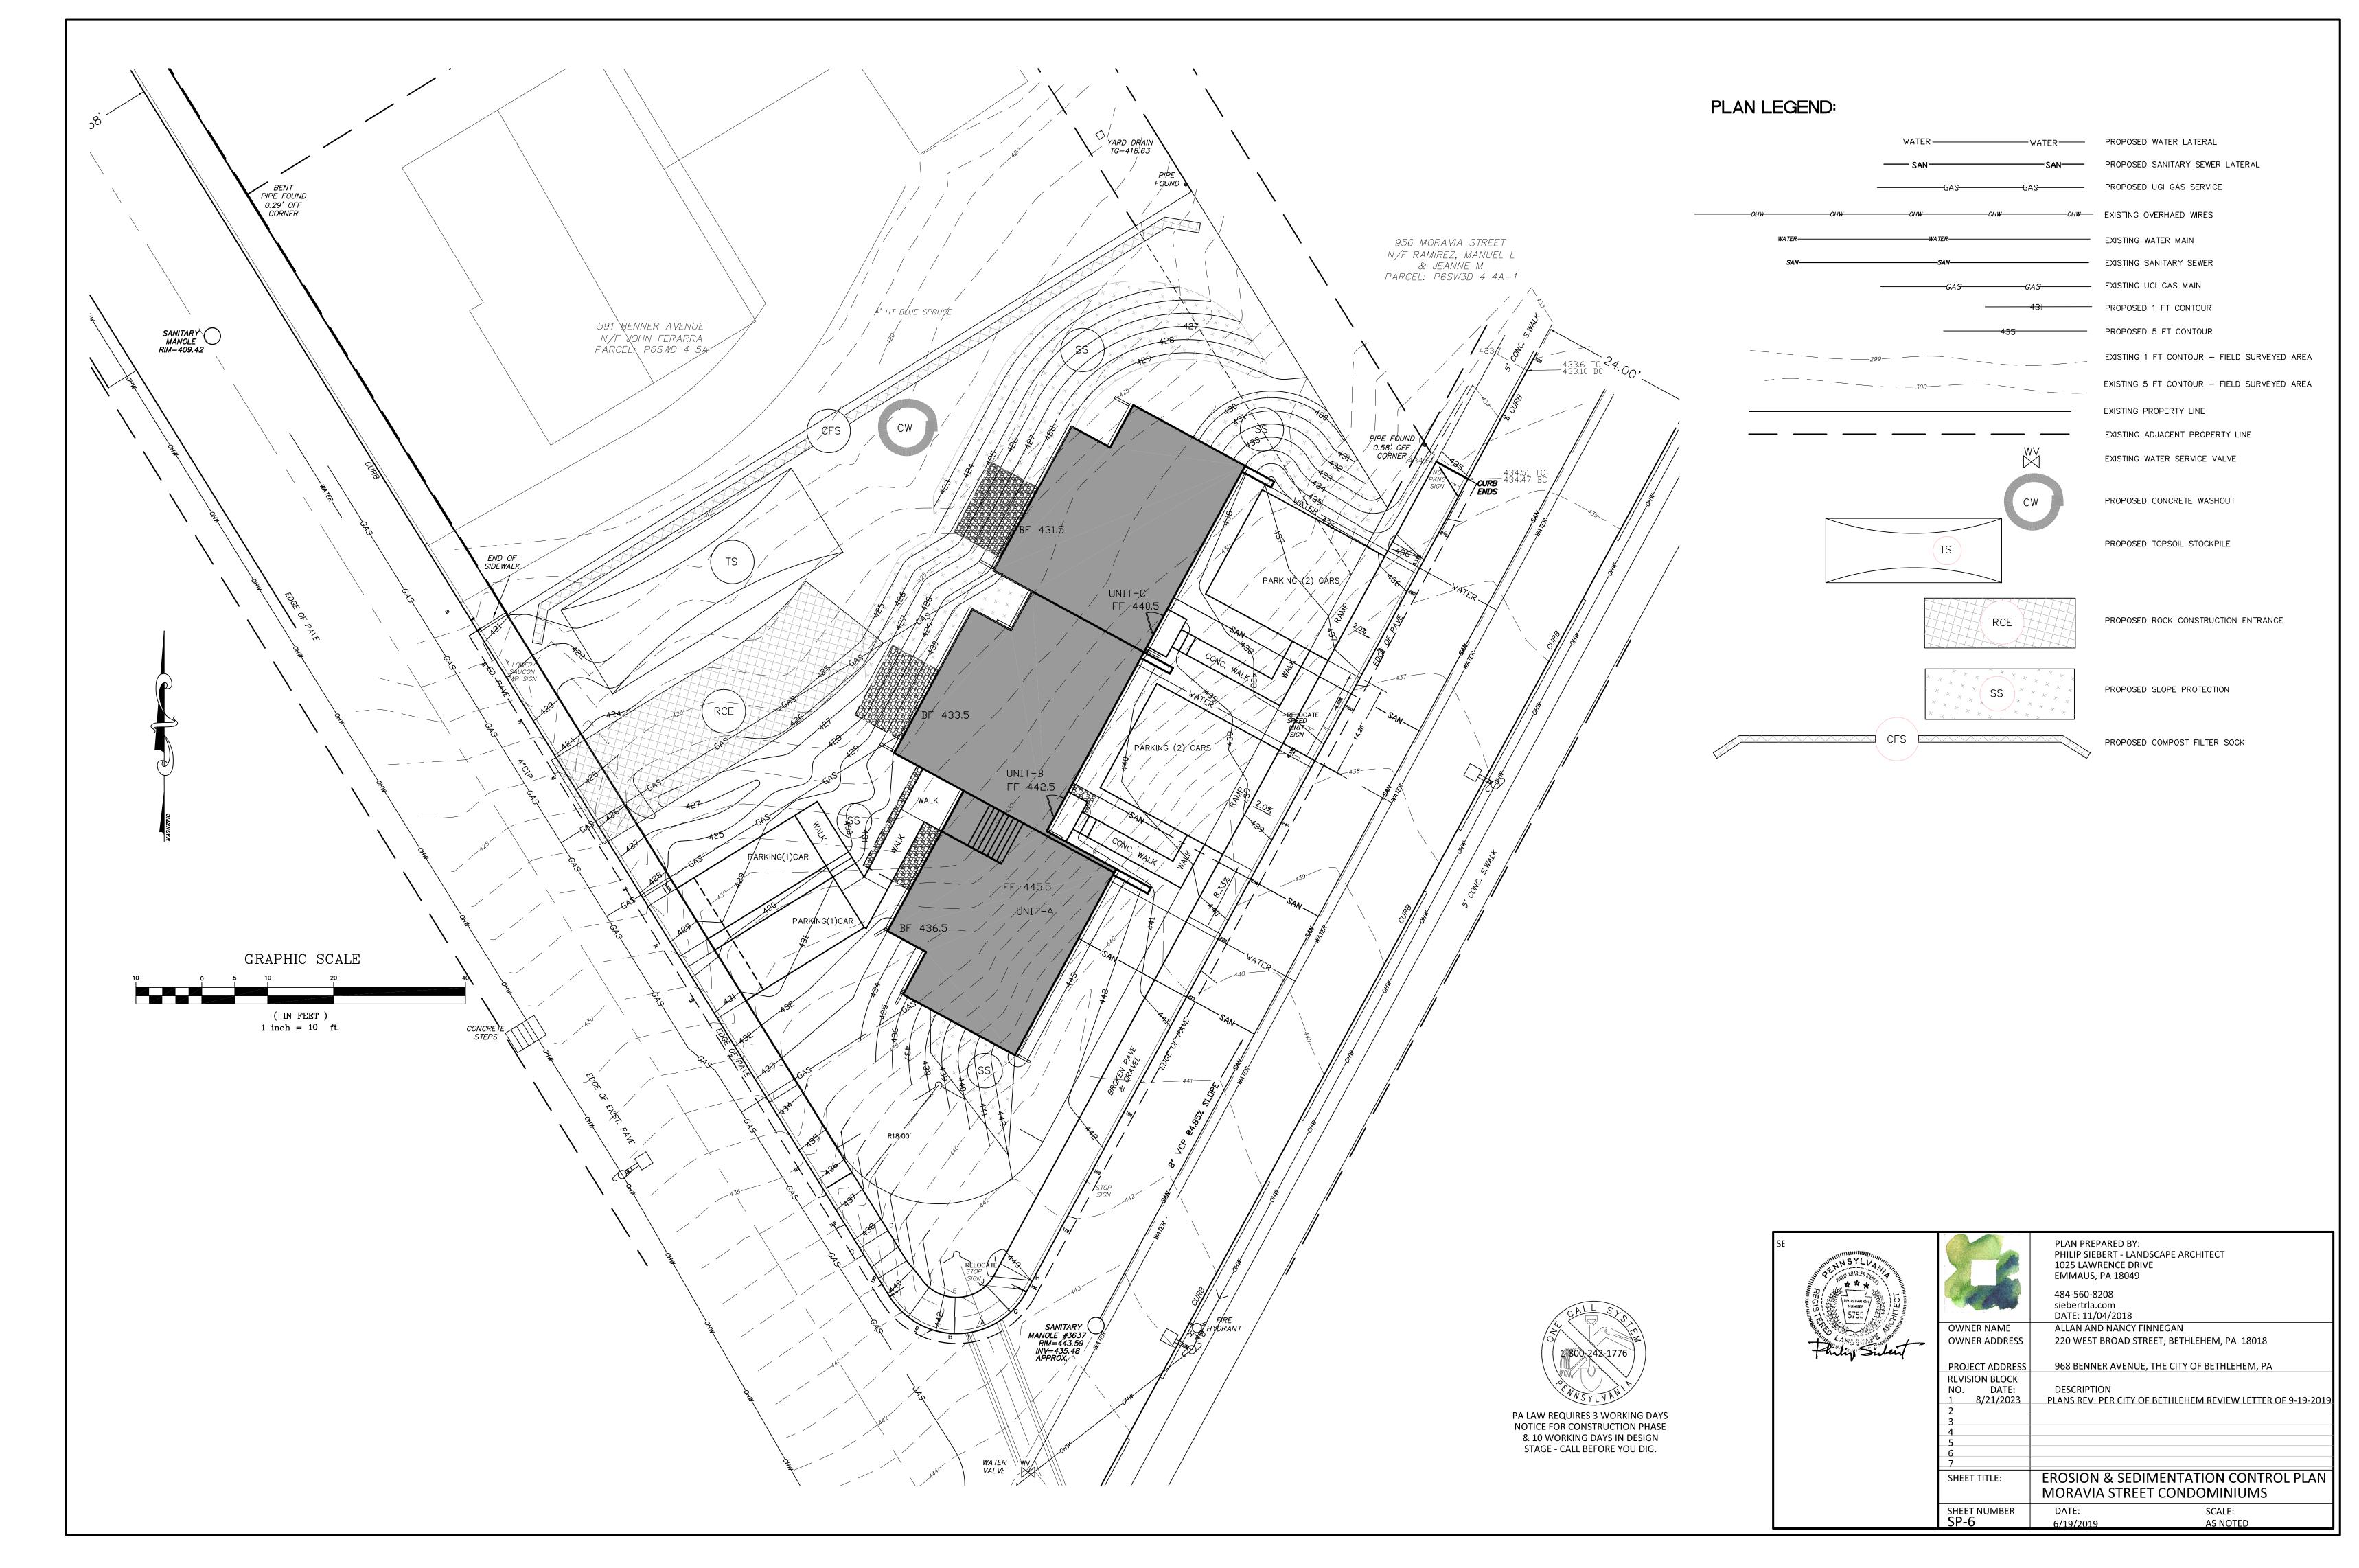

#### STANDARD E&S WORKSHEET # 21

-	•	·
PROJECT NAME:	MORAVIA STREET CONDOMI	<u>NIUMS</u>
LOCATION:	CITY OF BETHLEHEM	
PREPARED BY:	PCS	DATE: 8-21-2023
CHECKED BY:		DATE:

**Temporary and Permanent Vegetative Stabilization Specifications** 

SPECIFICATIONS: The Department recommends the use of the Penn State publication, "Erosion Control and Conservation Plantings on Noncropland," as the standard to use for the selection of species, seed specifications, mixtures, liming and fertilizing, time of seeding, and seeding methods. Specifications for these items may also be obtained from PennDOT's Publication # 408, Section 804 or by contacting the applicable county conservation district. Upon selection of a reference, that reference should be used to provide all specifications for seeding, mulching, and soil amendments. The following specification will be used for this project:

specification will	be used for this project:				
(TEMPORARY)	*SPECIES:	ANNUAL RY	rEGRASS		
,	% PURE LIVE SEED:	80			%
	APPLICATION RATE:	40			LB./ACRE
	FERTILIZER TYPE:	10-20-20			(X-X-X)
	FERTILIZER APPL. RATE:	150			LB./ACRE
	LIMING RATE:	1			T./ACRE
	MULCH TYPE:	STRAW			
	MULCHING RATE:	3			T./ACRE
		_			
(PERMANENT)	TOPSOIL PLACEMENT DEPTH:	6			IN
	*SPECIES:		, PER.RY	E, FINE FES	
	% PURE LIVE SEED:	72	80	76	%
	APPLICATION RATE	_ <u>1</u> 21	33	08	LB./ACRE
	FERTILIZER TYPE:	<u>10-20-20</u> _			(X-X-X)
	FERTILIZER APPL. RATE:	780			LB./ACRE
	LIMING RATE:	3			T./ACRE
	MULCH TYPE:	STRAW			
	MULCHING RATE:	3			T./ACRE
	ANCHOR MATERIAL:	CELLULOS	SE FIBER		
	ANCHORING METHOD:	SPRAY			
RATE OF ANCHOR MATERIAL APPL.:		<u>1,000</u>			LB./ACRE
	SEEDING SEASON DATES:	<u>MAR. 15 T</u>	O OCT. 15		

KENTUCKY BLUEGRASS SHALL BE COMPOSED OF EQUAL PARTS, BY WEIGHT, OF NO LESS THAN (3) PATENTED VARIETIES, SUITED TO THIS LOCATION. SEED AT A RATE OF 5.4 POUNDS PER 1,000 SF OR 234 POUNDS PER ACRE.

#### 102.4(b)(5)(x)MAINTENANCE PROGRAM (INCLUDING INSPECTION SCHEDULE)

Until the site achieves final stabilization, the operator shall assure that the BMPs are implemented, operated, and maintained properly and completely. Maintenance shall include inspections of all BMP facilities. The operator will maintain and make available to the City of Bethlehem complete, written inspection logs of all those inspections. A report must be made of the inspections and kept on site. All maintenance work, including cleaning, repair, replacement, re-grading, and re-stabilization shall be performed immediately and noted as completed by the next inspection date.

Until the site is stabilized, all erosion and sediment BMPs must be maintained properly. Maintenance must include inspections of all erosion and sediment control BMPs after each runoff event and on a weekly basis, unless there has been no rainfall. Inspections may be done on two-week intervals in the dry season, if there has been no rain since the <u>last inspection.</u> All preventative and remedial maintenance work, including clean out, repair, replacement, regarding, reseeding, re-mulching, and re-netting, must be performed immediately. If erosion and sediment control BMPs fail to perform as expected, replacement BMPs, or modifications of those installed will be required.

See individual E&S BMP standard details on sheet SP-2 for required frequency.

Traffic shall not be permitted to cross compost filter socks.

Rock Construction Entrance thickness shall be constantly maintained to the specified dimensions by adding rock. All sediment deposited on paved roadways shall be removed and returned to the construction site immediately. If excessive amounts of sediment are being deposited on roadway, install wash rack. Washing the roadway or sweeping the deposits into roadway ditches, sewer, culverts, or other drainage ways is not acceptable. Sediment removed from BMPs shall be disposed of in landscaped areas outside of steep slopes, or drainage swales and immediately stabilized.

Immediately upon discovering unforeseen circumstances posing the potential for accelerated erosion and or sediment pollution, the operator shall implement appropriate BMPs to eliminate potential for accelerated erosion and/or sediment pollution.

ALL SEDIMENT CONTROL MEASURES AND FACILITIES SHALL BE INSTALLED AND MAINTAINED IN ACCORDANCE WITH THE PA D.E.P. EROSION AND SEDIMENT

POLLUTION CONTROL PROGRAM MANUAL, TECHNICAL GUIDANCE NUMBER 363-2134-008, DATED MARCH 2012.

SHOULD ANY MEASURES CONTAINED WITHIN THIS PLAN AND NARRATIVE PROVE INCAPABLE OF ADEQUATELY REMOVING SEDIMENT FROM ON-SITE STORM WATER RUNOFF PRIOR TO DISCHARGE FROM THE SITE OR OF STABILIZING THE SURFACES INVOLVED, ADDITIONAL MEASURES MUST BE IMMEDIATELY IMPLEMENTED BY THE CONTRACTOR TO ELIMINATE ALL SUCH PROBLEMS. CONTACT THE CITY OF BETHLEHEM. FOR GUIDANCE AND RECOMMENDATIONS PRIOR TO THE INSTALLATION OF

IMMEDIATELY AFTER EARTH DISTURBANCE ACTIVITIES CEASE, THE OPERATOR SHALL STABILIZE ANY AREA DISTURBED BY THE ACTIVITIES. DURING NON-GERMINATING PERIODS, MULCH MUST BE APPLIED AT THE SPECIFIED RATES. DISTURBED AREAS WHICH ARE NOT AT FINISHED GRADE AND WHICH WILL BE RE-DISTURBED WITHIN 1 YEAR MUST BE STABILIZED IN ACCORDANCE WITH THE TEMPORARY VEGETATIVE STABILIZATION SPECIFICATIONS. DISTURBED AREAS WHICH ARE AT FINISHED GRADE OR WHICH WILL NOT BE RE-DISTURBED WITHIN 1 YEAR MUST BE STABILIZED IN ACCORDANCE WITH THE PERMANENT VEGETATIVE

4. AT LEAST 7 DAYS BEFORE STARTING ANY EARTH DISTURBANCE ACTIVITIES, THE CONTRACTOR SHALL INVITE ALL CONTRACTORS INVOLVED IN THOSE ACTIVITIES, THE LANDOWNER, ALL APPROPRIATE MUNICIPAL OFFICIALS, THE EROSION AND SEDIMENTATION CONTROL PLAN PREPARER, AND A REPRESENTATIVE OF THE CITY OF BETHLEHEM, TO AN ON-SITE PRE-CONSTRUCTION MEETING. ALSO, AT LEAST 3 DAYS BEFORE STARTING ANY EARTH DISTURBANCE ACTIVITIES, ALL CONTRACTORS INVOLVED IN THOSE ACTIVITIES SHALL NOTIFY THE PENNSYLVANIA ONE CALL SYSTEM INC. AT 1-800-242-1776 FOR BURIED UTILITIES LOCATION.

ALL EARTH DISTURBANCE ACTIVITIES SHALL PROCEED IN ACCORDANCE WITH THE CONSTRUCTION SEQUENCE. EACH STAGE SHALL BE COMPLETED BEFORE ANY

6. IMMEDIATELY UPON DISCOVERING UNFORESEEN CIRCUMSTANCES POSING THE POTENTIAL FOR ACCELERATED EROSION AND/OR SEDIMENT POLLUTION, THE OPERATOR SHALL IMPLEMENT APPROPRIATE BEST MANAGEMENT PRACTICES TO ELIMINATE THE POTENTIAL FOR ACCELERATED EROSION AND/OR SEDIMENT POLLUTION.

BEFORE INITIATING ANY REVISION TO THE APPROVED EROSION AND SEDIMENT CONTROL PLAN OR REVISIONS TO OTHER PLANS. WHICH MAY ALTER THE EFFECTIVENESS OF THE APPROVED E&S CONTROL PLAN, THE OPERATOR MUST RECEIVE APPROVAL OF THE REVISIONS FROM THE CITY OF BETHLEHEM.

THE OPERATOR SHALL REMOVE FROM THE SITE, RECYCLE, OR DISPOSE OF ALL BUILDING MATERIALS AND WASTES IN ACCORDANCE WITH THE DEPARTMENT'S SOLID WASTE MANAGEMENT REGULATIONS AT 25 PA CODE 260.1 ET SEQ., 271.1 ET SEQ., AND 287.1 ET SEQ. THE CONTRACTOR SHALL NOT ILLEGALLY BURY, DUMP OR DISCHARGE ANY BUILDING MATERIAL OR WASTES AT THE SITE.

9. THE OPERATOR SHALL ASSURE THAT AN EROSION AND SEDIMENT CONTROL PLAN HAS BEEN APPROVED BY TEH CITY OF BETHLEHEM. AND IS BEING IMPLEMENTED AND MAINTAINED FOR ALL SOIL AND/OR ROCK SPOIL AND BORROW AREAS, REGARDLESS OF THEIR LOCATIONS.

10. AN AREA SHALL BE CONSIDERED TO HAVE ACHIEVED FINAL STABILIZATION WHEN IT HAS A MINIMUM 70% PERENNIAL VEGETATIVE COVER OR OTHER PERMANENT NON-VEGETATIVE COVER WITH A DENSITY SUFFICIENT TO RESIST ACCELERATED SURFACE EROSION AND SUBSURFACE CHARACTERISTICS SUFFICIENT TO RESIST SLIDING OR OTHER MOVEMENTS.

- 11. THE OPERATOR SHALL ASSURE THAT THE APPROVED EROSION AND SEDIMENT CONTROL PLAN IS PROPERLY AND COMPLETELY IMPLEMENTED.
- 12. UNTIL THE SITE ACHIEVES FINAL STABILIZATION, THE OPERATOR SHALL ASSURE THAT THE BEST MANAGEMENT PRACTICES ARE IMPLEMENTED, OPERATED, AND MAINTAINED PROPERLY AND COMPLETELY.
- 13. MULCH WITH MULCH CONTROL NETTING OR EROSION BLANKETS MUST BE INSTALLED ON ALL SLOPES 3:1 OR STEEPER.
- 14. WHERE NOT DELINEATED OTHERWISE, THE LIMITS OF CONSTRUCTION SHALL BE THE PROPOSED COMPOST FILTER SOCK LINE.

FOLLOWING STAGE IS INITIATED. CLEARING AND GRUBBING SHALL BE LIMITED ONLY TO THOSE AREAS DESCRIBED IN EACH STAGE.

15. MONAVIA ST. & BENNER AVE. ARE PUBLIC ACCESS WAYS. THEY SHALL BE KEPT CLEAR OF ALL MUD, STONES AND OTHER CONSTRUCTION DEBRIS. CLEANING, BROOMING AND/OR SWEEPING MAY BE REQUIRED ON A DAILY BASIS, OR EVEN MORE FREQUENTLY, ACCESS TO THE SITE SHALL BE LIMITED TO THE STONE TIRE CLEANING AREA AT THE PROPOSED ROCK CONSTRUCTION ENTRANCE ONLY. ADDITIONAL SNOW FENCE OR BERMS MAY BE REQUIRED TO LIMIT CONSTRUCTION VEHILE MOVEMENT.

16. SOME SOILS MAY BE PRONE TO THE FORMATION OF SINKHOLES. SHOULD A SINKHOLE BE ENCOUNTERED DURING GRADING/BACKFILL OPERATIONS, NOTIFY THE ARCHITECT AND THE CITY OF BETHLEHEM IMMEDIATELY FOR SUGGESTED REPAIR PROCEDURES.

17. THE OWNER WILL BE RESPONSIBLE FOR THE PROPER CONSTRUCTION, STABILIZATION, AND MAINTENANCE OF ALL EROSION AND SEDIMENTATION CONTROLS AND RELATED ITEMS INCLUDED WITHIN THESE PLANS.

18. EROSION AND SEDIMENT BMPS MUST BE CONSTRUCTED, STABILIZED, AND FUNCTIONAL BEFORE SITE DISTURBANCE BEGINS WITHIN THE TRIBUTARY AREAS OF

19. EROSION AND SEDIMENT CONTROL PLAN PREPARED BY: PHILIP SIEBERT (RLA #575 E) PHILIP SIEBERT- LANDACAPE ARCHITECT 1025 LAWRENCE DRIVE, EMMAUS, PA 18049 PHONE: 484-560-8208

20. ALL CONSTRUCTION WASTE MATERIAL AND DEBRIS SHALL BE REMOVED FROM THE SITE AND RECYCLED/DISPOSED IN ACCORDANCE WITH THE RULES AND REGULATIONS OF THOSE AGENCIES AND AUTHORITIES HAVING JURISDICTION.

THE CONTRACTOR IS ADVISED TO BECOME THOROUGHLY FAMILIAR WITH THE PROVISIONS OF APPENDIX 64, EROSION CONTROL RULES AND REGULATIONS, TITLE 25, PART-1, DEPARTMENT OF ENVIRONMENTAL PROTECTION, SUBPART C, PROTECTION OF NATURAL RESOURCES, ARTICLE III, WATER RESOURCES, CHAPTER 102,

22. STRAW MULCH SHALL BE APPLIED IN LONG STRANDS, NOT CHOPPED OR FINELY BROKEN.

23. SEDIMENT REMOVED FROM BMPS SHALL BE DISPOSED OF IN LANDSCAPED AREAS OUTSIDE OF STEEP SLOPES, WETLANDS, FLOODPLAINS OR DRAINAGE SWALES

24. UNTIL THE SITE IS STABILIZED, ALL EROSION AND SEDIMENT BMPS MUST BE MAINTAINED PROPERLY. MAINTENANCE MUST INCLUDE INSPECTIONS OF ALL FROSION AND SEDIMENT CONTROL BMPS AFTER FACH RUNOFF EVENT AND ON A WEEKLY BASIS. ALL PREVENTIVE AND REMEDIAL MAINTENANCE WORK, INCLUDING CLEAN OLL REPAIR REPLACEMENT. RE-GRADING. RE-SEEDING. RE-MULCHING. AND RE-NETTING. MUST BE PERFORMED IMMEDIATELY. IF EROSION AND SEDIMENT CONTROL BMPS FAIL TO PERFORM AS EXPECTED, REPLACEMENT BMPS OR MODIFICATIONS OF THOSE INSTALLED WILL BE REQUIRED.

25. FAILURE TO CORRECTLY INSTALL SEDIMENT CONTROL FACILITIES OR FAILURE TO PREVENT SEDIMENT LADEN RUNOFF FROM LEAVING THE CONSTRUCTION SITE OR FAILURE TO TAKE CORRECTIVE ACTIONS TO IMMEDIATELY RESOLVE FAILURES OF SEDIMENT CONTROL FACILITIES MAY RESULT IN ADMINISTRATIVE, CIVIL AND/OR CRIMINAL PENALTIES BEING INSTITUTED BY THE PENNSYLVANIA DEPARTMENT OF ENVIRONMENTAL PROTECTION AS DEFINED IN SECTION 602 OF THE CLEAN STREAMS LAW OF PENNSYLVANIA. THE CLEAN STREAMS LAW PROVIDES FOR UP TO \$10,000 PER DAY IN CIVIL PENALTIES, \$10,000 IN SUMMARY CRIMINAL PENALTIES, AND UP TO \$25.000 IN MISDEMEANOR CRIMINAL PENALTIES PER EACH VIOLATION.

26. CONSTRUCTION VEHICLES AND EQUIPMENT MAY NEITHER ENTER DIRECTLY ONTO, NOR EXIT DIRECTLY FROM THE PROJECT SITE ONTO MONROVIA ST. OR BENNER AVE. WITHOUT FIRST PASSING THROUGH THE ROCK CONSTRUCTION ENTRANCE.

27. NO DISTURBANCE WILL BE PERMITTED PROVIDING ACCESS TO THIS SITE FOR GRADING AND/OR ACQUIRING BORROW TO CONSTRUCT ANY BMPS.

28. A COPY OF THE APPROVED EROSION AND SEDIMENT CONTROL PLAN MUST BE AVAILABLE AT THE PROJECT SITE AT ALL TIMES.

#### E&S CONTROL STANDARD NOTES RELATING TO SEQUENCE OF CONSTRUCTION

1. AT LEAST 7 DAYS PRIOR TO STARTING ANY EARTH DISTURBANCE ACTIVITIES (INCLUDING CLEARING AND GRUBBING), THE OWNER AND/OR OPERATOR SHALL INVITE ALL CONTRACTORS, THE LANDOWNER, APPROPRIATE MUNICIPAL OFFICIALS, THE E&S PLAN PREPARER, TO AN ON-SITE PRECONSTRUCTION MEETING. CITY OF BETHLEHEM PLANNING DEPT.—CRAIG PEIFFER PHONE 610—997—7637 CITY OF BETHLEHEM ENGINEER —BASEL YANDEM, CHIEF ENGINEER PHONE 610—865—7051.

PLAN DESIGNER PHILIP SIEBERT, RLA - EMAIL phil@siebertrla.com PHONE 484-560-8208 2. UPON INSTALLATION OR STABILIZATION OF ALL PERIMETER SEDIMENT CONTROL BMPS AND AT LEAST 3 DAYS PRIOR TO PROCEEDING WITH THE BULK EARTH DISTURBANCE ACTIVITIES, THE PERMITTEE SHALL PROVIDE NOTIFICATION TO THE CITY. 3. AT LEAST 3 DAYS PRIOR TO STARTING ANY EARTH DISTURBANCE ACTIVITIES. OR EXPANDING INTO AN AREA PREVIOUSLY UNMARKED, THE PENNSYLVANIA ONE CALL SYSTEM INC. SHALL BE NOTIFIED AT 1-800-242-1776 FOR THE LOCATION OF EXISTING

4. ALL EARTH DISTURBANCE ACTIVITIES SHALL PROCEED IN ACCORDANCE WITH THE SEQUENCE PROVIDED ON THE PLAN DRAWINGS. DEVIATION FROM THAT SEQUENCE MUST BE APPROVED BY THE CITY ENGINEER PRIOR TO IMPLEMENTATION. EACH STEP OF THE SEQUENCE SHALL BE COMPLETED BEFORE PROCEEDING TO THE NEXT STEP, EXCEPT WHERE NOTED.

UNDERGROUND UTILITIES.

PLAN PREPARER.

#### EROSION AND SEDIMENTATION CONTROL STAGING OF OPERATIONS AND EARTHMOVING ACTIVITIES CONSTRUCTION OF A 3 UNIT CONDOMINIUM BUILDING

NO SOIL DISTURBANCE SHALL TAKE PLACE UNTIL THE LOT IS ISOLATED FROM OFF SITE RUNOFF BY THE PLACEMENT OF THE COMPOST FILTER SOCKS ON THE DOWNSLOPE SIDE OF THE DISTURBANCE, PER THE SIZING TABLE LOCATED ON SHEET SP-8. THE TEMPORARY E&S CONTROL BMPS ARE SIZED WITH THE UNDERSTANDING THAT THE SITE WILL RECEIVE NO SIGNIFICANT RUNOFF

NO CLEARING AND/OR GRUBBING OF THIS SITE MAY TAKE PLACE UNTIL ALL POSSIBLE EROSION AND SEDIMENTATION CONTROLS, AS OUTLINED, HAVE BEEN INSTALLED AND ARE FUNCTIONAL. MULCHING, WITHOUT SEEDING, CAN BE USED AS AN INTERIM STABILIZATION CONTROL DURING NON-GROWING SEASONS OF THE YEAR. DISTURB ONLY AREAS THAT REQUIRE INSTALLATION OF E&S CONTROLS UNTIL CONTROLS ARE STABILIZED AND FUNCTIONAL. ENSURE THAT E&S CONTROLS ARE FUNCTIONAL PRIOR TO DISTURBING TRIBUTARY AREAS. WEEKLY AND AFTER EACH RUNOFF EVENT, ALL TEMPORARY EROSION CONTROL FACILITIES SHALL BE CHECKED AND CLEANED. ALL SILT REMOVED DURING THE CLEANING OPERATIONS, IF SUITABLE, SHALL BE INCORPORATED INTO THE EARTHWORK AS FILL WASTED ON THE SITE, AS DIRECTED BY THE ENGINEER. AT THE END OF EACH DAY ANY SEDIMENT DEPOSITED ON THE ADJACENT ROADWAY SYSTEM IS TO BE REMOVED, RETURNED TO THE SITE, AND STABILIZED. PRIOR TO STABILIZATION, ANY E&S PROBLEMS WHICH OCCUR AND REQUIRE ADDITIONAL MEASURES. SHOULD HAVE IMMEDIATE ACTION TAKEN TO CORRECT THE

THE CONTRACTOR IS RESPONSIBLE FOR DEVELOPING AND HAVING AN APPROVED EROSION AND SEDIMENTATION CONTROL PLAN FOR ANY OFFSITE WASTE OR BORROW AREAS.

BEFORE DISPOSING OF SOIL OR RECEIVING BORROW FOR THE SITE, THE OPERATOR MUST ASSURE THAT EACH SPOIL OR BORROW AREA HAS AN EROSION AND SEDIMENT CONTROL PLAN APPROVED BY THE CITY OF BETHLEHEM . AND WHICH IS BEING IMPLEMENTED AND MAINTAINED ACCORDING TO CHAPTER 102 REGULATIONS. THE OPERATOR SHALL ALSO NOTIFY THE CITY OF BETHLEHEM IN WRITING OF ALL RECEIVING SPOIL AND BORROW AREAS WHEN THEY HAVE BEEN IDENTIFIED.

NOTIFICATION OF THE CITY — THE CONTRACTOR SHALL PROVIDE NOTICE TO THE CITY OF BETHLEHEM A MINIMUM OF 7 DAYS PRIOR TO THE START OF EARTHMOVING ACTIVITIES. THE GENERAL CONTRACTOR SHALL NOTIFY THE PENNSYLVANIA ONE CALL SYSTEM, INC. AT 1-800-242-1776 TO LOCATE BURIED UTILITIES A MINIMUM OF THREE DAYS PRIOR TO THE START OF ANY EARTHMOVING ACTIVITIES.

<u>CONSTRUCTION SEQUENCE</u> 1. EACH STAGE OF CONSTRUCTION MUST BE COMPLETED AND STABILIZED PRIOR TO COMMENCING THE NEXT STAGE. 2. A PRECONSTRUCTION MEETING WITH THE GOVERNING AUTHORITIES MUST BE SCHEDULED PRIOR TO ANY EARTH DISTURBANCE 3. ALL STRUCTURES ASSOCIATED WITH THE CONSTRUCTION OF SEDIMENT REMOVAL FACILITIES MUST BE ON SITE PRIOR TO EARTH

DISTURBANCE. 4. AT LEAST 7 DAYS BEFORE STARTING ANY EARTH DISTURBANCE ACTIVITIES, THE CONTRACTOR SHALL INVITE ALL CONTRACTORS INVOLVED IN THOSE ACTIVITIES, THE LANDOWNER, ALL APPROPRIATE MUNICIPAL OFFICIALS, THE EROSION AND SEDIMENTATION CONTROL PLAN PREPARER. TO AN ONSITE PRE-CONSTRUCTION MEETING.

5. ALL EARTH DISTURBANCE ACTIVITIES SHALL PROCEED IN ACCORDANCE WITH THE FOLLOWING SEQUENCE. EACH STAGE SHALL BE COMPLETED BEFORE ANY FOLLOWING STAGES ARE INITIATED. 6. CLEARING AND GRUBBING SHALL BE LIMITED ONLY TO THOSE AREAS DESCRIBED IN EACH STAGE.

7. IMMEDIATELY UPON DISCOVERING UNFORESEEN CIRCUMSTANCES POSING THE POTENTIAL FOR ACCELERATED EROSION AND/OR SEDIMENT POLLUTION, THE OPERATOR SHALL IMPLEMENT APPROPRIATE BEST MANAGEMENT PRACTICES TO ELIMINATE THE POTENTIAL FOR SUCH ACCELERATED EROSION AND/OR SEDIMENT POLLUTION.

8. BEFORE INITIATING ANY REVISIONS TO THE APPROVED EROSION AND SEDIMENT CONTROL PLANS WHICH MAY ALTER THE EFFECTIVENESS OF THE APPROVED E&S CONTROL PLAN, THE OPERATOR MUST RECEIVE APPROVAL OF THE REVISIONS FROM THE CITY OF BETHLEHEM.

INSTALL THE ROCK CONSTRUCTION ENTRANCE, FROM BENNER AVENUE, WHERE INDICATED ON THE E&S PLAN SHEET SP-6. 'S SHALL BE THE ONLY CONSTRUCTION ENTRANCE BUILT OR USED TO ENTER THE SITE. IMMEDIATELY AFTER EARTH DISTURBANCE ACTIVITIES CEASE, THE OPERATOR SHALL STABILIZE ANY AREAS DISTURBED BY THE ACTIVITIES. DURING NON-GERMINATING PERIODS, MULCH MUST BE APPLIED AT THE SPECIFIED RATES. DISTURBED AREAS, WHICH ARE NOT AT FINISHED GRADE AND WHICH WILL BE RE-DISTURBED WITHIN 1 YEAR MUST BE STABILIZED IN ACCORDANCE WITH THE TEMPORARY VEGETATIVE STABILIZATION SPECIFICATIONS. DISTURBED AREAS WHICH ARE AT FINISHED GRADE OR WHICH WILL NOT BE RE-DISTURBED WITHIN 1 YEAR MUST BE STABILIZED IN ACCORDANCE WITH THE PERMANENT VEGETATIVE STABILIZATION

SPECIFICATIONS. 11. INSPECT AND REPAIR THE EXISITNG STABILIZED ROCK CONSTRUCTION ENTRANCE AS SHOWN ON THESE PLANS. STABILIZE ANY 12. INSPECT ALL PREVIOUSLY INSTALLED COMPOST FILTER SOCKS, WHERE INDICATED THROUGHOUT THE ENTIRE PROJECT AREA. CONSTRUCTION AREA HAS BEEN COMPLETED. SPOILS HAVE BEEN DISPOSED OF OFF-SITE. TOPSOIL IS STOCKPILED ON SITE IN THE DESIGNATED AREA FOR LATER USE, PROCEED AS FOLLOWS.

14. ROUGH GRADE THE PROJECT SITE FOR THE CONCRETE WORK AND DRIVEWAY PAVEMENT. ALL SLOPES OF 3:1 OR GREATER ARE TO BE IMMEDIATELY PROTECTED WITH EROSION CONTROL MATTING. THE MINOR INTERCEPTION SWALE WILL ALSO BE COMPLETED AT THIS TIME AND IT'S DISCHARGE POINT PROTECTED WITH A STONE FILTER BERM, INSTALLED PER THE DETAILS ON SP-8. ALL STORMWATER FROM THESE AREAS WILL CONTINUE AS SHEET FLOW TOWARD THE COMPOST FILTER SOCK AT THE NORTHERN PROPERTY LINE, AND TO THE MINOR INTERCEPTION SWALE NEAR BENNER AVENUE. THERE IS NO IMPERVIOUS SURFACE CONTRIBUTING RUNOFF TO THIS DRAINAGE PATH, AND MINIMAL CONCENTRATED FLOWS ARE ANTICIPATED DURING THIS PERIOD. SHOULD CONDITIONS DIFFER, ADDITIONAL TEMPORARY EROSION CONTROL MEASURES, SUCH AS A ROCK FILTER, OR WEIGHTED SEDIMENT FILTER TUBES ARE TO BE PLACED IN THE AREAS OF CONCENTRATED FLOW, AT THE DIRECTION OF THE

15. INSPECT & IF NECESSARY, REPAIR THE COMPOST SOCK CONCRETE WASHOUT WHERE INDICATED ON THESE PLANS. IMPERVIOUS LINER IS TO BE INSTALLED BENEATH THIS CONCRETE WASHOUT AREA. 16. CONCRETE SIDEWALKS AND STEPS WILL BE FORMED, BASE MATERIAL PLACED & COMPACTED, REINFORCING WIRE MESH INSTALLED, AND CONCRETE POURED. ONCE THE CONCRETE HAS CURED, THE AREA SURROUNDING THE HOUSE MAY BE BACKFILLED AND BROUGHT TO FINAL GRADE.

17. HOME CONSTRUCTION, AND ANY REMAINING EXTERIOR UTILITY INSTALLATIONS WILL CONTINUE SIMULTANEOUSLY. 18. THE INTERCEPTION SWALE TO BENNER AVE. WILL BE COMPLETED. A ROCK FILTER BERM MUST BE INSTALLED, AS SHOWN, IMMEDIATELY AFTER THE SWALES ARE CONSTRUCTED. THE SWALE WILL BE FINISH GRADED, TOPSOIL SPREAD, SEEDED AND IMMEDIATELY PROTECTED WITH EROSION CONTROL MATTING FOR BOTH SLOPE AND SWALE STABILIZATION. 19. THE MINOR INFILTRATION SWALE IS NOT TO RECEIVE RUNOFF UNTIL THE AREA TRIBUTARY TO THE SWALE IS COMPLETELY STABILIZED. EROSION CONTROL MATTING IS TO BE INSTALLED ON ANY REMAINING STEEP BANKS GREATER THAN 2:1 SLOPE. ROCK FILTER OUTLET MUST BE INSTALLED IN THE SWALE, AS SHOWN. UPON SUITABLE VEGETATIVE STABILIZATION OF THE SWALES, THE ROOF GUTTERS AND DOWNSPOUTS CAN BE INSTALLED.

21. THE SITE WILL BE CLEARED OF CONSTRUCTION EQUIPMENT AND DEBRIS. ONCE THE SITE HAS A MINIMUM UNIFORM 70% PERENNIAL VEGETATIVE COVER OR OTHER PERMANENT NON-VEGETATIVE COVER WITH A DENSITY SUFFICIENT TO RESIST ACCELERATED SURFACE EROSION, ALL TEMPORARY BMP'S CAN BE REMOVED. THE TEMPORARY BMP'S INCLUDE THE ROCK CONSTRUCTION ENTRANCE, SILT SOCK, AND 48 INCH CONSTRUCTION FENCING. ONCE REMOVED THE AREAS WHERE BMP'S ARE REMOVED FROM WILL BE SEEDED, MULCHED, AND STABILIZED. 22. THE PERMITTEE SHALL BE REQUIRED TO SUBMIT AN AS-BUILT PLAN TO THE CITY OF BETHLEHEM FOR FINAL REVIEW &

20. WHEN FINAL PAVING OF THE DRIVEWAY IS COMPLETED, THE ENTIRE AREA WILL SEEDED PER THE PERMANENT SEEDING

#### STANDARD E&S PLAN NOTES

done in accordance with the approved E&S plan. A copy of the approved drawings (stamped, signed and dated by the reviewing agency) must be available at the project site at all times. The reviewing agency shall be notified of any changes to the approved plan prior to implementation of those changes. The reviewing agency may require a written submittal of those changes for review and approval at its discretion. 2. At least 7 days prior to starting any earth disturbance activities, including clearing and grubbing, the owner and/or operator shall invite all contractors, the landowner, appropriate municipal officials, the E&S plan preparer, to an on—site preconstruction

3. At least 3 days prior to starting any earth disturbance activities, or expanding into an area previously unmarked, the Pennsylvania One Call System Inc. shall be notified at 1-800-242-1776 for the location of existing underground utilities.

1. All earth disturbances, including clearing and grubbing as well as cuts and fills shall be

4. All earth disturbance activities shall proceed in accordance with the sequence provided on the plan drawings. Deviation from that sequence must be approved in writing from the City prior to implementation.

5. Areas to be filled are to be cleared, grubbed, and stripped of topsoil to remove trees, vegetation, roots and other objectionable material. 6. Clearing, grubbing, and topsoil stripping shall be limited to those areas described in each stage of the construction sequence. General site clearing, grubbing and topsoil

stripping may not commence in any stage or phase of the project until the E&S BMPs specified by the BMP sequence for that stage or phase have been installed and are functioning as described in this E&S plan. 7. At no time shall construction vehicles be allowed to enter areas outside the limit of

disturbance boundaries shown on the plan maps. These areas must be clearly marked before clearing and grubbing operations begin. 8. Existing topsoil shall be stripped and removed from the site, because there is no space available for the temporary storage of the required topsoil. Topsoil required for the establishment of vegetation shall be hauled to the site and placed to a depth of 6

inches, as required, upon completion of the site grading and pavement installation. 9. Immediately upon discovering unforeseen circumstances posing the potential for accelerated erosion and/or sediment pollution, the operator shall implement appropriate best management practices to minimize the potential for erosion and sediment pollution and notify the township. 10. All building materials and wastes shall be removed from the site and recycled or disposed of in accordance with the Department's Solid Waste Management Regulations at

25 Pa. Code 260.1 et seq., 271.1, and 287.1 et. seq. No building materials or wastes or unused building materials shall be burned, buried, dumped, or discharged at the site. 11. All off—site waste and borrow areas must have an E&S plan approved by the local conservation district or the Department fully implemented prior to being activated. 12. The contractor is responsible for ensuring that any material brought on site is clean

Form FP—001 must be retained by the property owner for any fill material affected by a spill or release of a regulated substance but qualifying as clean fill due to analytical testing. 13. All pumping of water from any work area shall be done according to the procedure

described in this plan, over undisturbed vegetated areas. 14. Vehicles and equipment must enter the site on the existing paved driveway and cross the proposed rock construction entrance at the edge of the existing parking lot to gain access to the site.

15. Until the site is stabilized, all erosion and sediment BMPs shall be maintained properly. Maintenance shall include inspections of all erosion and sediment BMPs after each runoff event and on a weekly basis. All preventative and remedial maintenance work, including clean out, repair, replacement, regrading, reseeding, remulching and renetting must be performed immediately. If the E&S BMPs fail to perform as expected, replacement BMPs, or modifications of those installed will be required. 16. A log showing dates that E&S BMPs were inspected as well as any deficiencies found

to township officials at the time of inspection. 17. Sediment tracked onto any public roadway or sidewalk shall be returned to the construction site by the end of each work day and disposed in the manner described in this plan. In no case shall the sediment be washed, shoveled, or swept into any roadside ditch, storm sewer, or surface water.

and the date they were corrected shall be maintained on the site and be made available

18. All sediment removed from BMPs shall be disposed of in the manner described on the 19. Areas which are to be topsoiled shall be scarified to a minimum depth of 3 to 5

inches — 6 to 12 inches on compacted soils — prior to placement of topsoil. Areas to be vegetated shall have a minimum 4 inches of topsoil in place prior to seeding and mulching. Fill outslopes shall have a minimum of 2 inches of topsoil. 20. All fills shall be compacted as required to reduce erosion, slippage, settlement, subsidence or other related problems. Fill intended to support buildings, structures and conduits, etc. shall be compacted in accordance with local requirements or codes. 21. All earthen fills shall be placed in compacted layers not to exceed 9 inches in

22. Fill materials shall be free of frozen particles, brush, roots, sod, or other foreign or objectionable materials that would interfere with or prevent construction of satisfactory

23. Frozen materials or soft, mucky, or highly compressible materials shall not be

incorporated into fills. 24. Fill shall not be placed on saturated or frozen surfaces. 25. Seeps or springs encountered during construction shall be handled in accordance with the standard and specification for subsurface drain or other approved method.

26. All graded areas shall be permanently stabilized immediately upon reaching finished grade. Cut slopes in competent bedrock and rock fills need not be vegetated. Seeded areas within 50 feet of a surface water, or as otherwise shown on the plan drawings, shall be blanketed according to the standards of this plan. 27. Immediately after earth disturbance activities cease in any area or subarea of the

project, the operator shall stabilize all disturbed areas. During non-germinating months, mulch or protective blanketing shall be applied as described in the plan. Areas not at finished grade, which will be reactivated within 1 year, may be stabilized in accordance with the temporary stabilization specifications. Those areas which will not be reactivated within 1 year shall be stabilized in accordance with the permanent stabilization specifications.

28. Permanent stabilization is defined as a minimum uniform, perennial 70 cover or other permanent non-vegetative cover with a density sufficient to reside tative accelerated erosion. Cut and fill slopes shall be capable of resisting failure due to slumping, sliding, or other movements. 29. E&S BMPs shall remain functional as such until all areas tributary to them are


permanently stabilized or until they are replaced by another BMP approved by the Township. 30. Upon completion of all earth disturbance activities and permanent stabilization of all

disturbed areas, the owner and/or operator shall contact township for an inspection prior to removal/conversion of the E&S BMPs. 31. After final site stabilization has been achieved, temporary erosion and sediment BMPs must be removed or converted to permanent post construction stormwater management

BMPs. Areas disturbed during removal or conversion of the BMPs shall be stabilized immediately. In order to ensure rapid revegetation of disturbed areas, such removal/conversions are to be done only during the germinating season. 32. Upon completion of all earth disturbance activities and permanent stabilization of all disturbed areas, the owner and/or operator shall contact the Township to schedule a final

### PLAN REFERENCE INFORMATION:

FIELD WORK AND BOUNDARY ARE BASED ON A SURVEY DONE BY N.D. REMY ASSOCAIATES, LLC. DATED 9/06/2018.

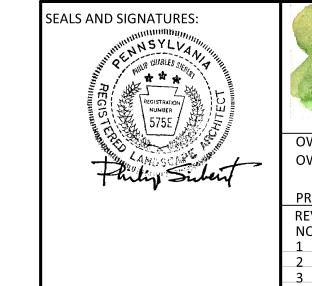

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SHEET NUMBER

SP-7

PLAN PREPARED BY: PHILIP SIEBERT - LANDSCAPE ARCHITECT .025 LAWRENCE DRIVE MMAUS, PA 18049 184-560-8208 iebertrla.com DATE: 11/04/2018

ALLAN AND NANCY FINNEGAN 220 WEST BROAD STREET, BETHLEHEM, PA 18018

968 BENNER AVENUE, THE CITY OF BETHLEHEM, PA REVISION BLOCK NO. DATE: 8/21/2023

PLANS REV. PER CITY OF BETHLEHEM REVIEW LETTER OF 9-19-2019 E&S CONTROL DETAILS AND NOTES SHEET TITLE: MORAVIA STREET CONDOMINIUMS

SCALE:


AS NOTED

DATE

6/19/2019

# **Rock Filter Outlet** OPTIONAL 6" COMPOST LAYER FIRMLY ANCHORED -OPTIONAL 6" SUMP


STANDARD CONSTRUCTION DETAIL # 4-6

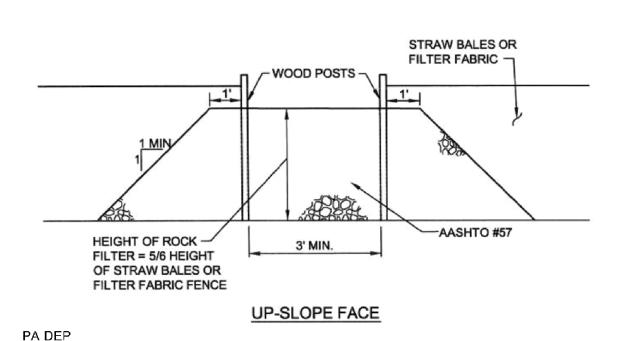

OUTLET CROSS-SECTION

A rock filter outlet shall be installed where failure of a silt fence or straw bale barrier has occurred due to concentrated flow. Anchored compost layer shall be used on upslope face in HQ and EV watersheds.

Sediment shall be removed when accumulations reach 1/3 the height of the outlet.

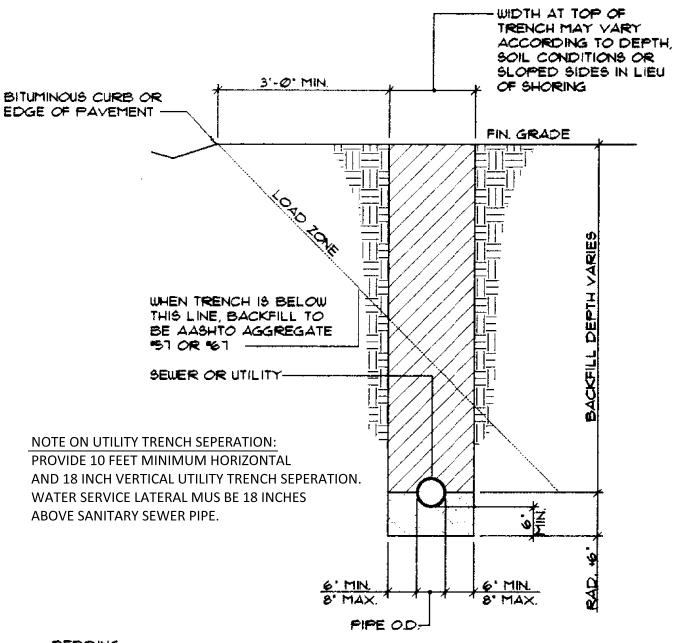

THE BEDDING SHALL HAVE A MINIMUM DEPTH OF (6) SIX INCHES BELOW ALL PIPE AND SHALL BE BACKFILLED WITH AASHTO \$1 OR \$61 (12) TWELVE INCHES BELOW ALL PIPE IN ROCK THEN EXTENDED UP THE HAUNCHES TO THE SPRINGLINE OF THE

BACKFILL: ALL STREET AND PARKING AREA CROSSING SHALL BE BACKFILLED TO SUBGRADE WITH AASHTO AGGREGATE "51 OR "67. IN ALL OTHER TRENCH AREAS BACKFILL FROM THE SPRINGLINE TO (!) ONE FOOT ABOVE THE TOP OF PIPE TO BE SELECTED MATERIAL (SELECTED MATERIAL IS FINELY DIVIDED MATERIAL FREE OF DEBRIS, ORGANIC MATERIAL, AND STONES), TAMPED IN (4) FOUR INCH LAYERS: THEN THE REMAINING BACKFILL FROM THE TRENCH MAY BE PLACED.

4) UTILITY PIPE TRENCHING, BEDDING AND BACKFILLING

## STANDARD CONSTRUCTION DETAIL #4-1 COMPOST FILTER SOCK 2"X 2"WOODEN STAKES PLACED 10' O.C. COMPOST FILTER SOCK BLOWN/PLACED FILTER MEDIA **UNDISTURBED AREA** SECTION VIEW NTS EXISTING CONTOURS FILTER SOCK PLAN VIEW

Sock fabric shall meet standards of Table 4.1. Compost shall meet the standards of Table 4.2.

NTS

Compost filter sock shall be placed at existing level grade. Both ends of the sock shall be extended at least 8 feet up slope at 45 degrees to the main sock alignment (Figure 4.1). Maximum slope length above any sock shall not exceed that shown on Figure 4.2. Stakes may be installed immediately downslope of the sock if so specified by the manufacturer.

#### Traffic shall not be permitted to cross filter socks.


**Filtrexx** 

Accumulated sediment shall be removed when it reaches half the aboveground height of the sock and disposed in the manner described elsewhere in the plan.

Socks shall be inspected weekly and after each runoff event. Damaged socks shall be repaired according to manufacturer's specifications or replaced within 24 hours of inspection.

Biodegradable filter socks shall be replaced after 6 months; photodegradable socks after 1 year. Polypropylene socks shall be replaced according to manufacturer's recommendations.

Upon stabilization of the area tributary to the sock, stakes shall be removed. The sock may be left in place and vegetated or removed. In the latter case, the mesh shall be cut open and the mulch spread as a soil supplement.

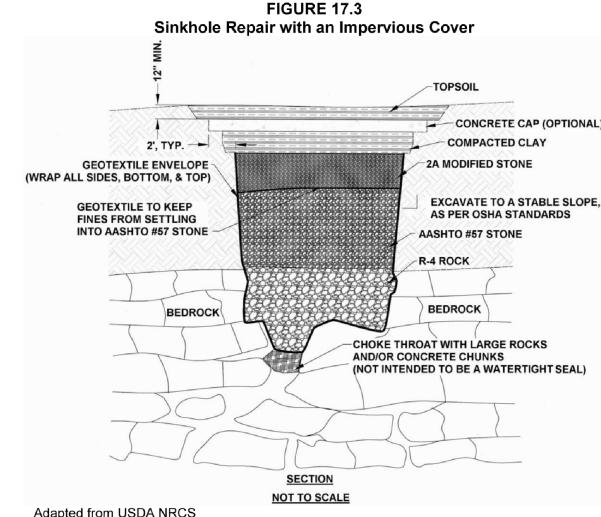

Loose material shall be excavated from the sinkhole and expose solution void(s) if possible. Enlarge sinkhole if necessary to allow for installation of filter materials. OSHA regulations must be followed at all times during excavation.

Geotextile shall be non-woven with a burst strength between 100 and 200 psi.

Select field stone(s) about 1.5 times larger than solution void(s) to form "bridge." Place rock(s) so no large openings exist along the sides. Stones used for the "bridge" and filters shall have a moderately hard rock strength and be resistant to abrasion and degradation. Shale and similar soft and/or non-durable rock are not acceptable.

Minimum thickness of R-4 rock is 18." AASHTO #57 stone thickness shall be 1/4 to 1/2 that of the R-4 rock. Minimum thickness of 2A modified crushed stone shall be 9". AASHTO #57 stone and 2A modified crushed stone shall be compacted after each placement.

Compacted clay seal shall be a minimum of 12" thick. Clay shall be placed in 6" to 9" lifts and thoroughly compacted.

Concrete cap, which is optional, shall be a minimum of 8" thick. Use 4,000 psi concrete with 6" X 6" - 6 gauge welded wire fabric, or # 3 rebar on 18" O.C. both ways.

Topsoil shall be a minimum of 12" thick. Grade for positive drainage away from sinkhole area.



Adapted from USDA NRCS Loose material shall be excavated from the sinkhole and expose solution void(s) if possible. Enlarge sinkhole if necessary to allow for installation of filter materials. OSHA regulations must be followed at all times during excavation.

**NOT TO SCALE** 

**FIGURE 17.3** 

Sinkhole Repair with an Impervious Cover

CONCRETE CAP (OPTIONAL)

**EXCAVATE TO A STABLE SLOPE.** 

AS PER OSHA STANDARDS

COMPACTED CLAY

2A MODIFIED STONE

**AASHTO #57 STONE** 

R-4 ROCK

BEDROCK \

(NOT INTENDED TO BE A WATERTIGHT SEAL

-CHOKE THROAT WITH LARGE ROCKS

AND/OR CONCRETE CHUNKS

Geotextile shall be non-woven with a burst strength between 100 and 200 psi.

2', TYP.

GEOTEXTILE ENVELOPE

**GEOTEXTILE TO KEEP** 

FINES FROM SETTLING

INTO AASHTO #57 STONE

(WRAP ALL SIDES, BOTTOM, & TOP)


Select field stone(s) about 1.5 times larger than solution void(s) to form "bridge." Place rock(s) so no large openings exist along the sides. Stones used for the "bridge" and filters shall have a moderately hard rock strength and be resistant to abrasion and degradation. Shale and similar soft and/or non-durable rock are not acceptable.

Minimum thickness of R-4 rock is 18." AASHTO #57 stone thickness shall be 1/4 to 1/2 that of the R-4 rock. Minimum thickness of 2A modified crushed stone shall be 9". AASHTO #57 stone and 2A modified crushed stone shall be compacted after each placement.

Compacted clay seal shall be a minimum of 12" thick. Clay shall be placed in 6" to 9" lifts and thoroughly compacted.

Concrete cap, which is optional, shall be a minimum of 8" thick. Use 4,000 psi concrete with 6" X 6" - 6 gauge welded wire fabric, or # 3 rebar on 18" O.C. both ways.

Topsoil shall be a minimum of 12" thick. Grade for positive drainage away from sinkhole area.

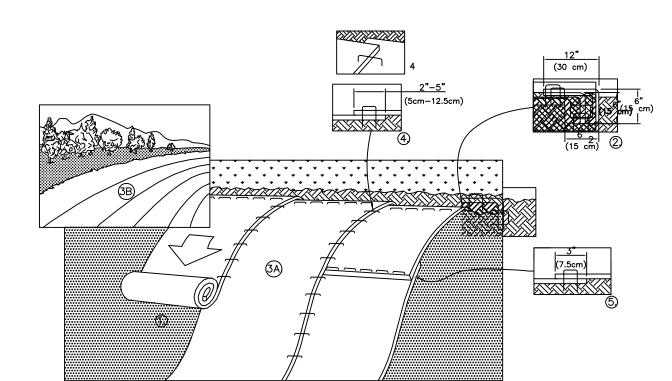


USE NAG ERONET S75 EROSION CONTROL BLANKET WITH STAPLE PATTERN "C" FOR ALL SLOPE AREAS INDICATED ON THE E&S CONTROL PLAN SHEET S&S-2.

. PREPARE SOIL BEFORE INSTALLING BLANKETS, INCLUDING ANY NECESSARY APPLICATION OF LIME, FERTILIZER, AND SEED. NOTE: WHEN USING CELL—O—SEED DO NOT SEED PREPARED AREA. CELL—O—SEED MUST BE INSTALLED WITH PAPER SIDE DOWN. 2. BEGIN AT THE TOP OF THE SLOPE BY ANCHORING THE BLANKET IN A 6" (15cm) DEEP X 6" (15cm) WIDE TRENCH WITH APPROXIMATELY 12" (30cm) OF BLANKET EXTENDED BEYOND THE UP—SLOPE PORTION OF THE TRENCH. ANCHOR THE BLANKET WITH A ROW OF STAPLES/STAKES APPROXIMATELY 12" (30cm) APART IN THE BOTTOM OF THE TRENCH. BACKFILL AND COMPACT THE TRENCH AFTER STAPLING. APPLY SEED TO COMPACTED SOIL AND FOLD REMAINING 12" (30cm) PORTION OF BLANKET BACK OVER SEED AND COMPACTED SOIL. SECURE BLANKET OVER COMPACTED SOIL WITH A ROW OF STAPLES/STAKES SPACED APPROXIMATELY 12" (30cm) APART ACROSS THE WIDTH OF THE BLANKET. 3. ROLL THE BLANKETS (A.) DOWN OR (B.) HORIZONTALLY ACROSS THE SLOPE. BLANKETS WILL UNROLL WITH APPROPRIATE SIDE

AGAINST THE SOIL SURFACE. ALL BLANKETS MUST BE SECURELY FASTENED TO SOIL SURFACE BY PLACING STAPLES/STAKES IN APPROPRIATE LOCATIONS AS SHOWN IN THE STAPLE PATTERN GUIDE. WHEN USING OPTIONAL DOT SYSTEM, STAPLES/STAKES SHOULD BE PLACED THROUGH EACH OF THE COLORED DOTS CORRESPONDING TO THE APPROPRIATE STAPLE PATTERN 4. THE EDGES OF PARALLEL BLANKETS MUST BE STAPLED WITH APPROXIMATELY 2"-5" (5cm-12.5cm) OVERLAP DEPENDING ON BLANKET TYPE. TO ENSURE PROPER SEAM ALIGNMENT, PLACE THE EDGE OF THE OVERLAPPING BLANKET (BLANKET BEING INSTALLED ON TOP) EVEN WITH THE COLORED SEAM STITCH ON THE PREVIOUSLY INSTALLED BLANKET. 5. CONSECUTIVE BLANKETS SPLICED DOWN THE SLOPE MUST BE PLACED END OVER END (SHINGLE STYLE) WITH AN APPROXIMATE 3" (7.5cm) OVERLAP. STAPLE THROUGH OVERLAPPED AREA, APPROXIMATELY 12" (30cm) APART ACROSS ENTIRE BLANKET WIDTH.

\*\*IN LOOSE SOIL CONDITIONS, THE USE OF STAPLE OR STAKE LENGTHS GREATER THAN 6" (15cm) MAY BE NECESSARY TO PROPERLY SECURE THE BLANKETS.

14649 HIGHWAY 41 NORTH, EVANSVILLE, INDIANA 47725 USA 1-800-772-2040 CANADA 1-800-448-2040 www.nagreen.com SLOPE STABILIZATION

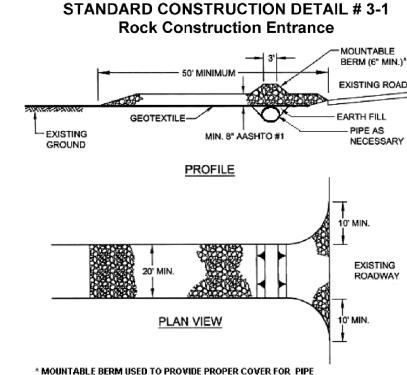


Modified from Maryland DOE

Remove topsoil prior to installation of rock construction entrance. Extend rock over full width of entrance.

Runoff shall be diverted from roadway to a suitable sediment removal BMP prior to entering rock construction entrance.

Mountable berm shall be installed wherever optional culvert pipe is used and proper pipe cover as specified by manufacturer is not otherwise provided. Pipe shall be sized appropriately for size of ditch being crossed.

MAINTENANCE: Rock construction entrance thickness shall be constantly maintained to the specified dimensions by adding rock. A stockpile shall be maintained on site for this purpose. All sediment deposited on paved roadways shall be removed and returned to the construction site immediately. If excessive amounts of sediment are being deposited on roadway, extend length of rock construction entrance by 50 foot increments until condition is alleviated or install wash rack. Washing the roadway or sweeping the deposits into roadway ditches, sewers, culverts, or other drainage courses is not acceptable.

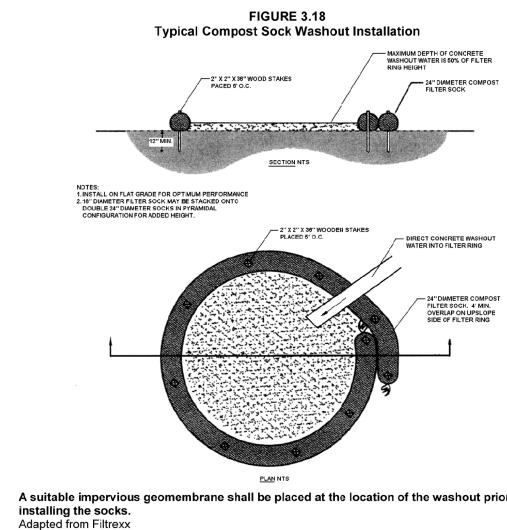

A suitable impervious geomembrane shall be placed at the location of the washout prior to

3 CONCRETE WASHOUT FACILITY



PLAN REFERENCE INFORMATION:

