
		APPLICATION FOR CERTIF	FICATE OF A	PPROPR	IATENESS	(COA)			
	Building address _	327 Broadway, Bethlehem PA 18015							
	Owner of building _	Larry Eighmy, Sycamore Hill Farm Deve	elopment	Phone					
	Owner's email & m								
		arry Eighmy	Phone:						
	Applicant's email &	r mailing address							
		Street and Number 301 Broadway, Suite 500	City Bethlehem		State PA	Zip Code 18015			
		APPLICANT MUST ATTENI	MEETING F	OR CASE	TO BE HE	ARD.			
	USE THE CHE	<u>CKLIST ON THE BACK OF TI</u>	HIS APPLICAT	TION TO	ENSURE Y	OUR SUBMISSION IS			
		_	COMPLETE.						
lis eg	storic & Architectu ular scheduled meetir	ral Review Board – Application fon the ng in order to be placed on the agen	orm, photographs da for the next m	, and draw eeting.	ings must be s	submitted 2 weeks prior to th	e		
i oi ub	uth Bethlehem & M mitted 2 weeks prior	Iount Airy Historic Conservatio , to the regular scheduled meeting in	n Commission order to be place	- Application	on form, photo genda for the i	ographs, and drawings must next meeting.	be		
1.	PHOTOGRAPHS - Photographs of your building and neighboring buildings must accompany your application.								
2.	TYPE OF WORK	PROPOSED - Check all that apply	y. Please bring a	ny samples	or manufactu	res specifications for			
	products you will u			•					
	Trim and dec	orative woodwork		Skylights					
	_X Siding and M	lasonry	X	Metal wo					
	X Roofing, gutt	er and downspout		Light fixt					
	Windows, do	ors, and associated hardware		Signs					
	Storm windo	ws and storm doors		Demolitic	on				
	Shutters and	associated hardware		Other					
	Paint (Submi	t color chips - HARB only)							
1	DD A WINCS OF DI	DODOCED WARE Descripted to	*	Maria			_		
		ROPOSED WORK - Required dra							
		N (10) COPIES OF DRAWING	GS, PHOTOGR	APHS, A	<u>PPLICATIO</u>	ON FORM, AND ANY			
SP	<u>PECIFICATIONS</u>								
		Alteration, renovation, restoration (1/4 or 1/8"=1'0" scale drawings required IF walls or openings altered.)							
		New addition (1/4" or 1/8"=1'0" scale drawings: elevations, floor plans, site plan)							
		New building or structure (1/4" or 1/8"=1'0" scale drawings: elevations, floor plans, site plan)							
	Demolition, removal of building features or building (1/4" or 1/8"=1'0" scale drawings: elevation of remaining site								
	and site plan)								
	A scale drawin	ng, with an elevation view, is require	ed for all sign sub	mittals					
1.	DESCRIBE PROJ See attached descript	JECT – Describe any work checked ion	in #2 and #3 abo	ve. Attach	additional she	eets as needed.			

City of Bethlehem, Pennsylvania
APPLICATION FOR CERTIFICATE OF APPROPRIATENESS (COA)
Building address 327 Broadway, Bethlehem PA 18015
Owner of buildingLarry Eighmy, Sycamore Hill Farm Development Phone Phone
Owner's email & mailing address
Applicant Larry Eighmy Phone:
Applicant's email & mailing address
Street and Number 301 Broadway, Suite 500 City Bethlehem State PA Zip Code 18015
24, 0000
<u>APPLICANT MUST ATTEND MEETING FOR CASE TO BE HEARD.</u> USE THE CHECKLIST ON THE BACK OF THIS APPLICATION TO ENSURE YOUR SUBMISSION IS
COMPLETE.
Historic & Architectural Review Board – Application form, photographs, and drawings must be submitted 2 weeks prior to the regular scheduled meeting in order to be placed on the agenda for the next meeting.
South Bethlehem & Mount Airy Historic Conservation Commission - Application form, photographs, and drawings must b submitted 2 weeks prior to the regular scheduled meeting in order to be placed on the agenda for the next meeting.
1. PHOTOGRAPHS - Photographs of your building and neighboring buildings must accompany your application.
2. TYPE OF WORK PROPOSED - Check all that apply. Please bring any samples or manufactures specifications for
products you will use in this project.
Trim and decorative woodwork Skylights
_X Siding and MasonryX Metal work
X Roofing, gutter and downspout Light fixtures
Windows, doors, and associated hardware Signs
Storm windows and storm doors Demolition
Shutters and associated hardware Other
Paint (Submit color chips – HARB only)
3. DRAWINGS OF PROPOSED WORK – Required drawings must accompany your application. Please submit ONE
ORIGINAL AND TEN (10) COPIES OF DRAWINGS, PHOTOGRAPHS, APPLICATION FORM, AND ANY
SPECIFICATIONS
Alteration, renovation, restoration (1/4 or 1/8"=1'0" scale drawings required IF walls or openings altered.) X New addition (1/4" or 1/8"=1'0" scale drawings: elevations, floor plans, site plan)
New building or structure (1/4" or 1/8"=1'0" scale drawings: elevations, floor plans, site plan)
Demolition, removal of building features or building (1/4" or 1/8"=1'0" scale drawings: elevation of remaining site
and site plan)
A scale drawing, with an elevation view, is required for all sign submittals
4. DESCRIBE PROJECT - Describe any work chacked in #2 and #2 shows Americal Project in the second se
 DESCRIBE PROJECT – Describe any work checked in #2 and #3 above. Attach additional sheets as needed. See attached description
200 And accompliant
7 . 2 5
5. APPLICANT'S SIGNATURE DATE: 2/1/21
6. OWNER'S SIGNATURE DATE: 2/1/21
DAID.

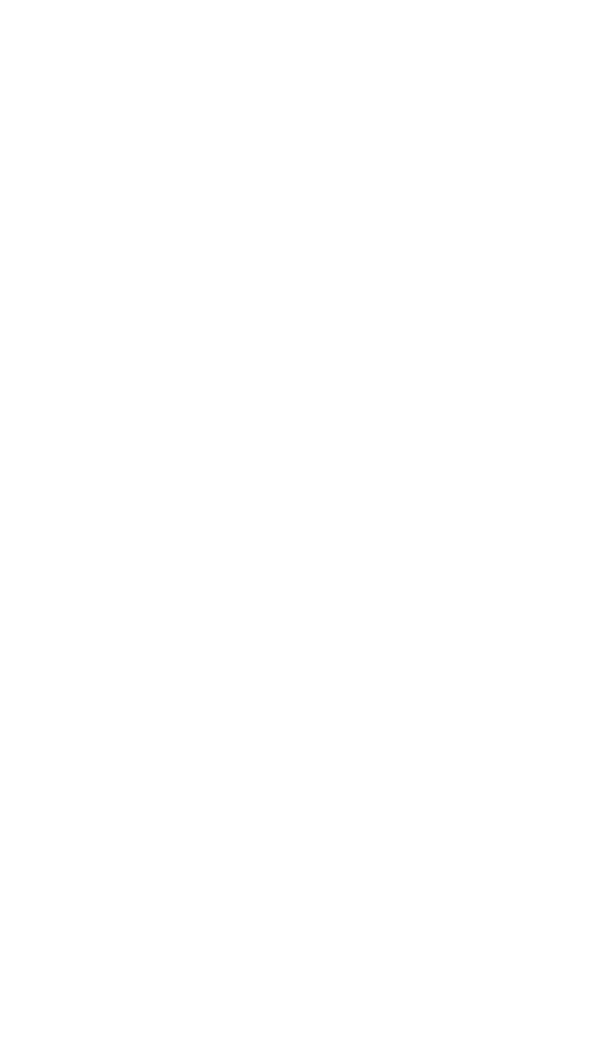

HCC Submission - February 2021

327 Broadway


We are respectfully seeking approval for revisions to the design of the Fourth Street facade (previously submitted) and new rooftop elements that build off the Commission's previous feedback. The attached drawings highlight each area in detail. A brief explanation of each area follows:

Biergarten - As previously discussed, the rooftop "biergarten" facing Broadway has been prepped for fit-out, and final design of the space is ongoing. At the July 2020 HCC hearing, feedback about the shade structure was taken into consideration. A permanent steel and glass shade structure is proposed in lieu of the seasonal fabric structure, which was not well received. A detailed guard rail is also shown for approval. These elements will be visible from the southwest on Broadway. The design of these elements is intended to be minimal and transparent, painted a light grey to blend with the sky beyond.

4th Street facade - You may recall the previous submission showed cast stone and glass at the 4th Street ground level. The use of this garage has been reconsidered and it is now intended to be open with no garage door. A ventilated security screening is proposed at the other bays of the facade. Two options are shown for HCC feedback. We seek approval to proceed with the Commission's preferred option.

Lastly, a 3rd floor addition is proposed on the roof facing Fourth Street (north half of roof). This was previously shown as two modular units, now conceived as one site-built addition, as constructability and cost come into focus. The addition is set back from the 4th street parapet to create a balcony and accent the stepped parapet of the historic facade (evidence suggests the stepped parapet was lopped off to create the current roofline). The design of the addition builds off the existing facade's massing, scale, and proportion. It utilizes new materials to distinguish it from the historic brick and cast stone, and ties into the material palette of the ground level garage facade. A rooftop equipment screen is used to provide symmetry.

Thank you for your continued feedback on this project, and we look forward to implementing a design that adds to this building's rich history!

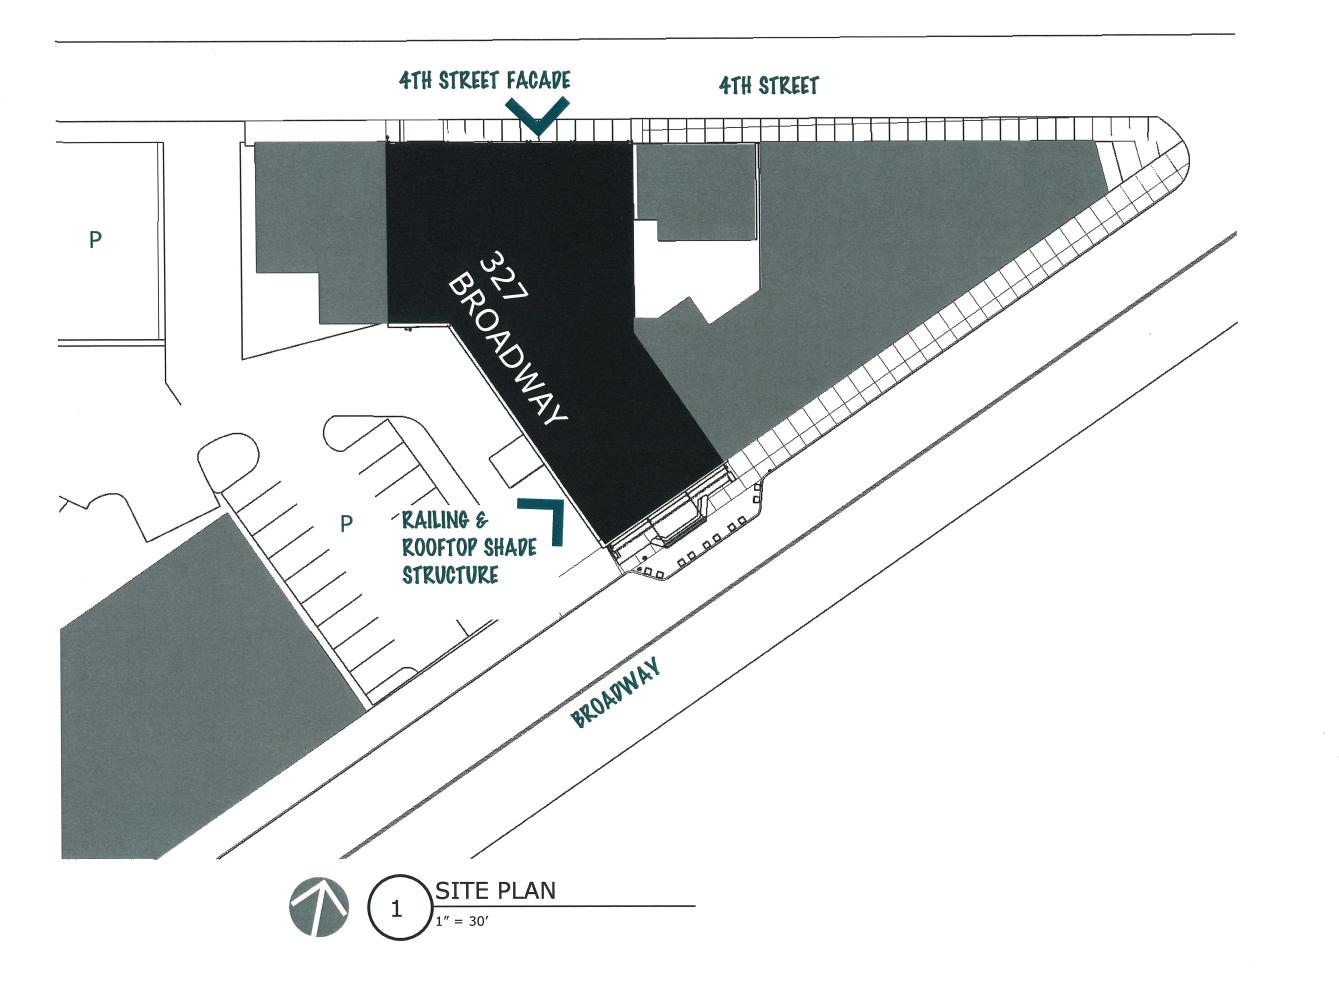



Professional Seal

CONTRACTOR

Elevate Construction Partnership

CLIENT

The Stone House Group 301 Broadway Bethlehem, PA 18015

PROJECT

327 BROADWAY

DRAWN BY EAN

ISSUE

FEB. 2021 HCC submission

SITE PLAN

CONTRACTOR

Elevate Construction Partnership

CLIENTThe Stone House Group 301 Broadway Bethlehem, PA 18015

PROJECT

327 **BROADWAY**


DRAWN BY EAN

ISSUE

FEB. 2021 HCC submission

ROOF PLAN



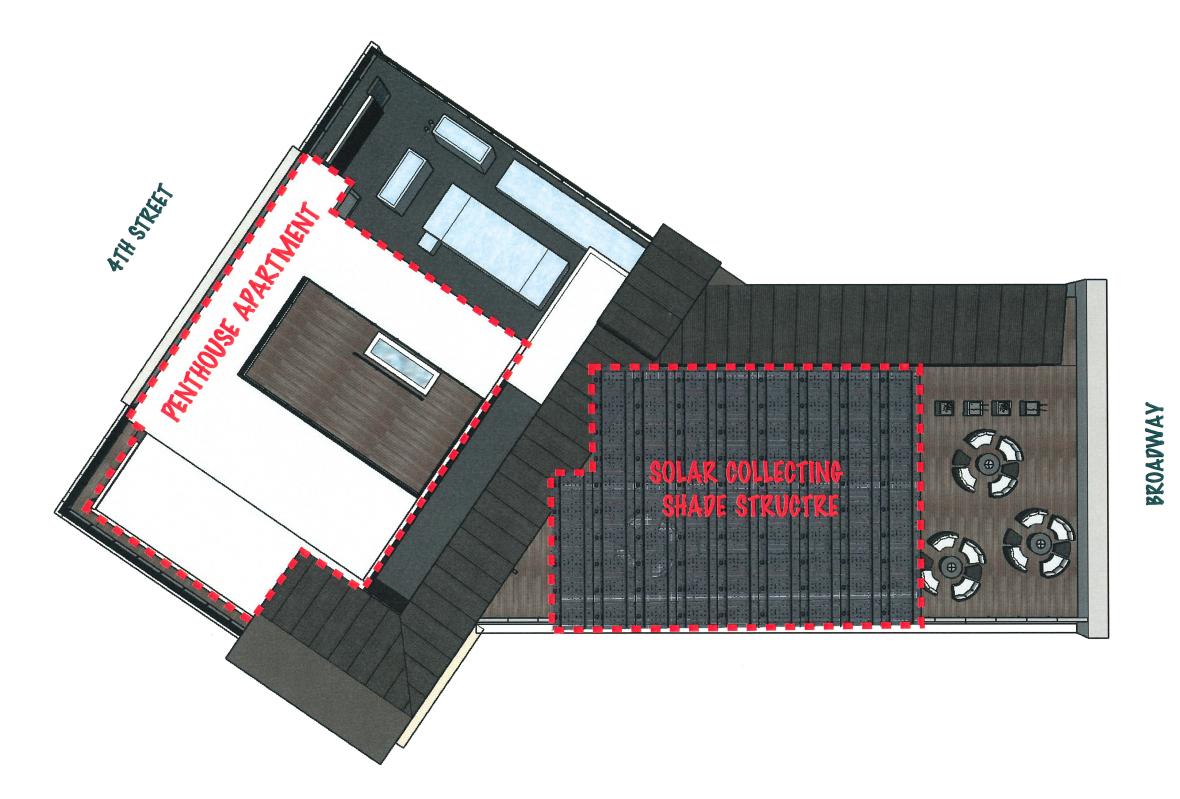



SEEKING APPROVAL FOR:

- 1. STEEL AND GLASS SOLAR COLLECTING SHAPE STRUCTURE
- 2. GUARD RAIL ALONG WEST EDGE OF ROOF, ATTACH TO INSIDE OF EXISTING PARAPET, SEE DETAIL ON $\rm p\ 9$



www.EastSpruceDesignBuild.com

Professional Seal

CONTRACTOR

Elevate Construction Partnership

CLIENT

The Stone House Group 301 Broadway Bethlehem, PA 18015

PROJECT

327 BROADWAY

DRAWN BY EAN

ISSUE

FEB. 2021 HCC submission

ROOFTOP BIERGARTEN


Proposed - Rooftop biergarten improvements (seen from Broadway)

NTS





PROPOSED DESIGN

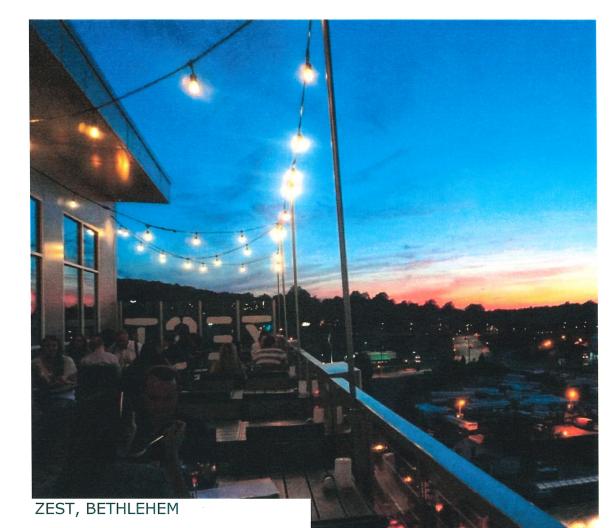









www.EastSpruceDesignBuild.com

Professional Seal

CONTRACTOR

Elevate Construction Partnership

CLIENT

The Stone House Group 301 Broadway Bethlehem, PA 18015

PROJECT


327 BROADWAY

DRAWN BY EAN

ISSUE

FEB. 2021 HCC submission

BIERGARTEN AESTHETIC

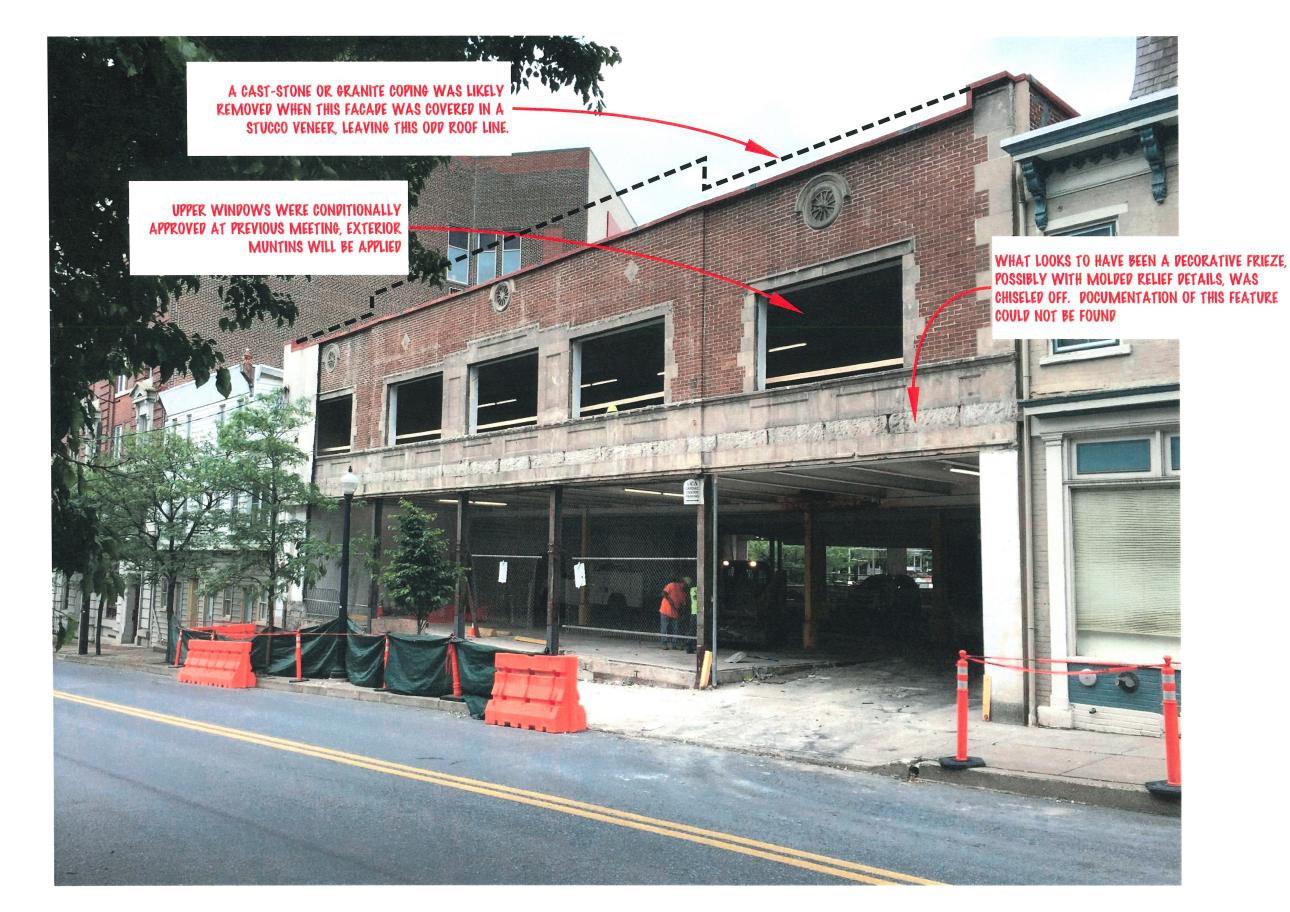



Professional Seal

CONTRACTOR

Elevate Construction Partnership

CLIENT

The Stone House Group 301 Broadway Bethlehem, PA 18015

PROJECT

327 BROADWAY

DRAWN BY EAN

ISSUE

FEB. 2021 HCC submission

UNCOVERED FACADE

Existing Condition - north elevation

NTS



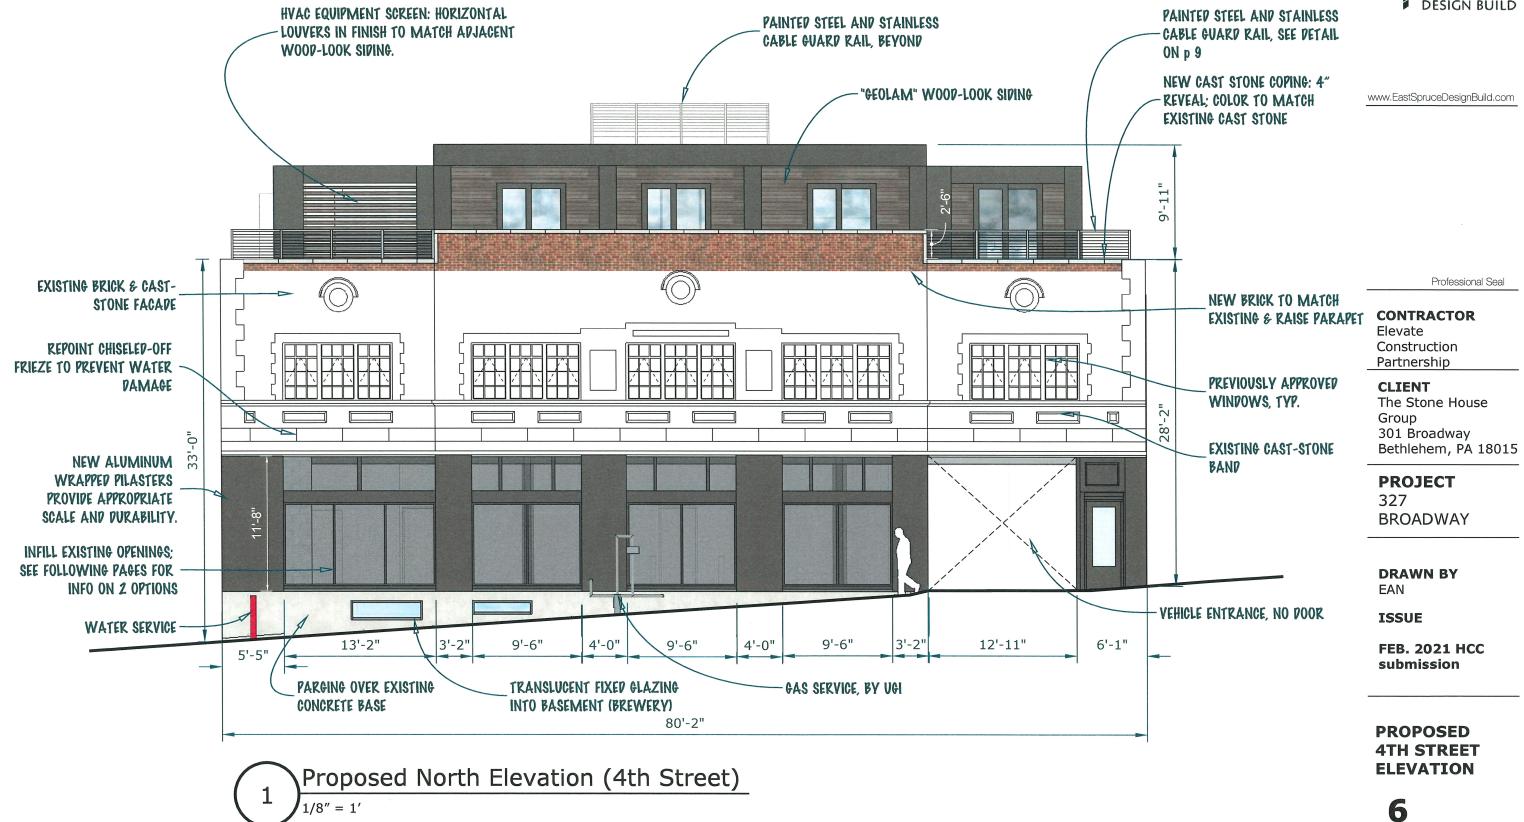






IMAGE ABOVE IS FROM THE NEW STREET PARKING DECK. THE SAME MATERIALS ARE PROPOSED HERE.

STOREFRONT SIZES, LOCATIONS, AND MULLION DESIGN RELATE TO THE ORIGINAL BUILDING'S STOREFRONT GLASS.

ALUMINUM STOREFRONT FRAMING IN DARK BRONZE

PERFORATED METAL SCREEN IN BLACK, AS SEEN ABOVE

NO GARAGE DOOR

Professional Seal

CONTRACTOR

Elevate Construction Partnership

CLIENT

The Stone House Group 301 Broadway Bethlehem, PA 18015

PROJECT

327 BROADWAY

DRAWN BY EAN

ISSUE

FEB. 2021 HCC submission

4TH STREET - option 1

Infill option 1 - perforated metal screen





GEOLAM EXTRUDED ALUMINUM HORIZONTAL SLATS ARE 5 1/8" X 2 1/8" AND ATTACHED TO A CONCEALED STEEL FRAME

PERFORATED METAL SCREENS IN BLACK, ARE SHOWN IN UPPER PORTION OF OPENING TO MAINTAIN HISTORIC PROPORTIONS (SAME PRODUCTS AS PREVIOUS PAGE)

THIS PROPUCT WAS SELECTED FOR DURABILITY AND AS A VISUAL CONNECTION TO THE SIDING OF THE ROOFTOP ADDITION (SAME MANUFACTURER AND COLORWAY)

NO GARAGE POOR

Professional Seal

CONTRACTOR

Elevate Construction Partnership

CLIENT

The Stone House Group 301 Broadway Bethlehem, PA 18015

PROJECT

327 BROADWAY

DRAWN BY EAN


ISSUE

FEB. 2021 HCC submission

4TH STREET - option 2

Infill option 2 - Geolam horizontal slats



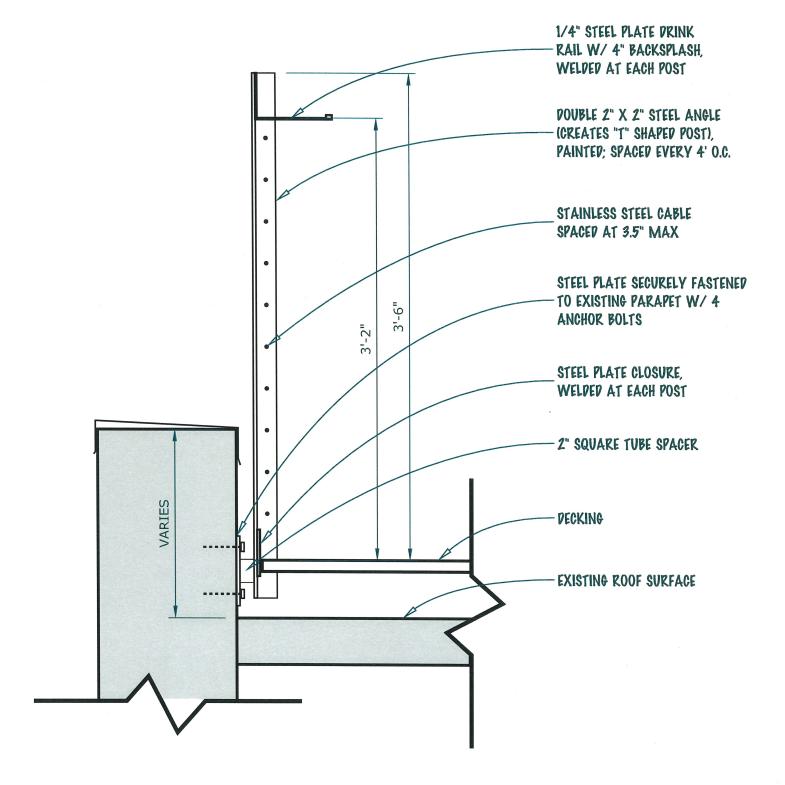

Guard rail detail

NTS

www.EastSpruceDesignBuild.com

Professional Seal

CONTRACTOR

Elevate Construction Partnership

CLIENT

The Stone House Group 301 Broadway Bethlehem, PA 18015

PROJECT

327 BROADWAY

DRAWN BY EAN

ISSUE

FEB. 2021 HCC submission

RAILING DETAIL