




PHOTOMETRIC FOOTCANDLE LEGEND ______

NOTES:

1. HANOVER LANTERN 31832RLED LIGHT TO BE INSTALLED ON A 9' HIGH HANOVER LANTERN ANCHOR BASE POST, MODEL 344, ROUND FLUTE ALUMINUM POST, 8.5" BASE DIAMETER, 18.25" BASE HEIGHT.

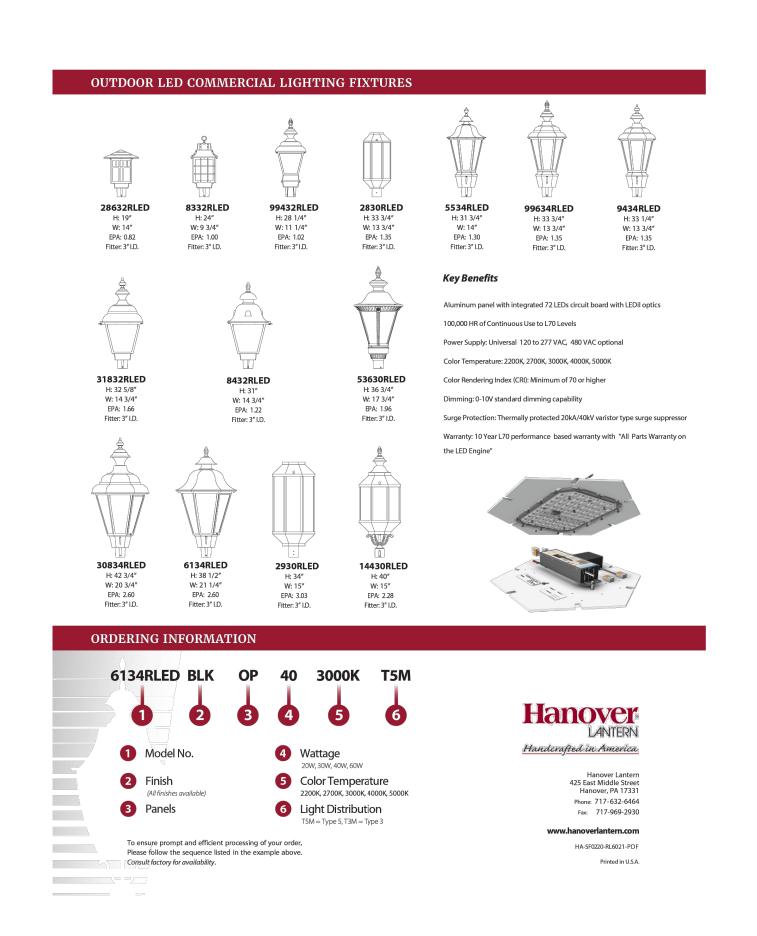

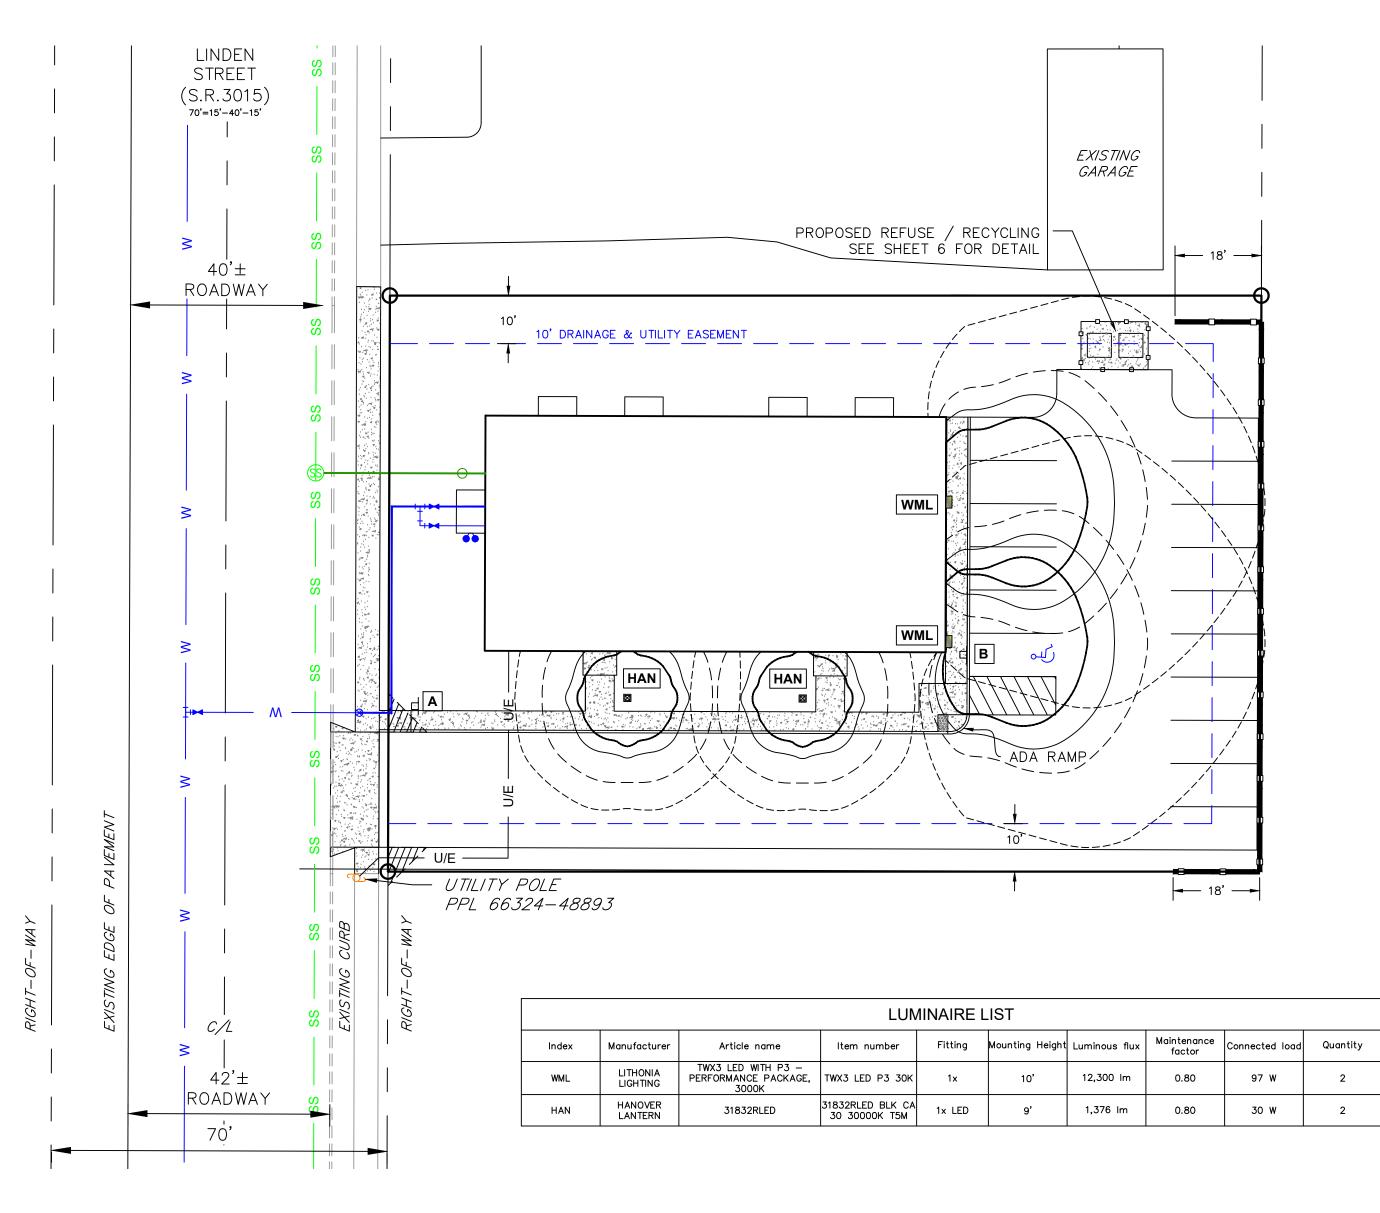

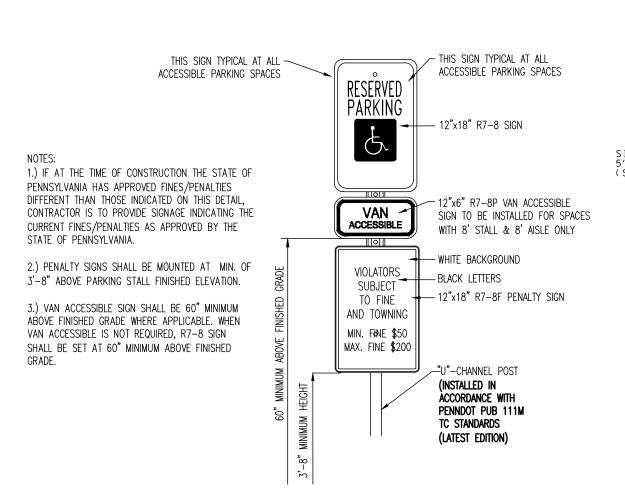



GRAPHIC SCALE

(IN FEET)

1 inch = 20 ft.

DETECTABLE WARNING SURFACE (TYP) 5'-0" MAX SLOPE: ZERO ± 2.00% SIDEWALK WIDTH -₹ 8.33 % MAX 5'-0" MIN (SEE NOTE 20, SHEET 1) --- PLAIN CEMENT CONCRETE DEPRESSED CURB PLAIN CEMENT CONCRETE — DEPRESSED CURB 8.33% MAX SLOPE - GRADE BREAK TYPE 1A CURB RAMP NOTE:


CURB RAMP DEPICTED HEREIN IS INTENDED AS A GENERAL GUIDELINE ONLY. CONTRACTOR SHALL BE RESPONSIBLE TO CONSTRUCT CURB RAMP IN ACCORDANCE WITH THE DESIGN STANDARDS CONTAINED IN PENNDOT PUBLICATION 72M, RC-67M, LATEST EDITION TO THE MAXIMUM EXTENT PRACTICABLE AND TO THE SATISFACTION OF THE CITY OF BETHLEHEM ENGINEERING BUREAU OR BUILDING CODE INSPECTOR, AS APPLICABLE.

> CURB RAMP DETAIL PennDOT TYPE 1A

> > NO SCALE

CALL BEFORE YOU DIG! PENNSYLVANIA LAW REQUIRES 3 WORKING DAYS NOTICE FOR CONSTRUCTION PHASE AND 10 WORKING DAYS IN DESIGN STAGE - STOP CALL Pennsylvania One Call System, Inc. 1 CITY OF BETHLEHEM REVIEW LETTER |BRH|REH| 10/16/24 1-800-242-1776 REV. BY CHK DATE

SIGN SCHEDULE DESCRIPTION SIZE QTY SYMBOL SERIES STOP SIGN B R7-8 RESERVED PARKING 12" X 18" 1

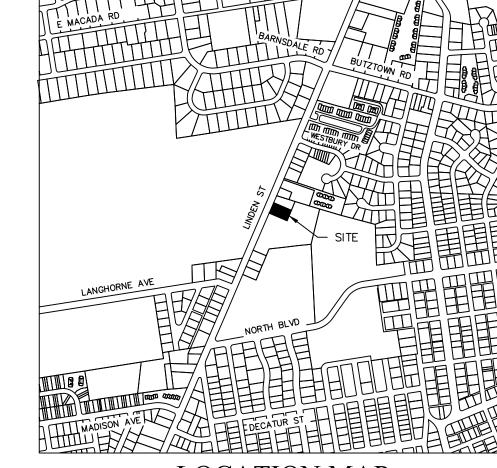

LOCATION MAP

SCALE: 1'' = 1,000'



TWX3 LED LED Wall Luminaire

TWX LED wall pack family, a ground-up design that has the low initial cost customers demand while providing superior performance and a traditional form. The TWX3 LED is energy efficient, saving up to 84% in energy costs when replacing a metal halide luminaire. Offering an expected service life of more than 20 years, the TWX3 LED eliminates frequent lamp and ballast replacements associated with traditional technologies

The Adjustable Light Output (ALO) feature allows the contractor to set the light output during installation, to a level perfectly suited for the job site. The TWX3 LED ALO luminaires can replace anything from a 100W to 400W metal halide luminaire.

WX	LED	Family	Overview	

1	W b	DI	Lumens (4000K)								
Luminaire	Voltage	Photocell	P1	P2	P3	P4					
TWX1 LED	MVOLT (120-277V)	YES	1,600	2,950							
TWX2 LED	MVOLT (120-277V), 347V, 480V	YES	3,250	4,400	5,250	6,850					
TWX3 LED	MVOLT (120-277V), 347V	YES	8,800	10,650	12,900	13,850					

Ordering Information

EXAMPLE: TWX3 LED ALO 40K MVOLT DDBXD

Series	Package Color Temperatur		emperature	Voltage	Options		Finish					
TWX3 LED	P1 P2 P3 P4 ALO	8,800 lumens 10,650 lumens 12,900 lumens 13,850 lumens 2,900 - 13,850 lumens	30K 40K 50K	3000K 4000K 5000K	MVOLT (120-277V) 347	PE	Photocell, Button Type	DDBXD DBLXD DWHXD DNAXD	Dark bronze Black White Natural aluminum	DDBTXD DBLBXD DWHGXD DNATXD	Textured dark bronze Textured black Textured White Textured natural aluminum	

Accessories *543982 RK1 PEB SHLD U Button style photocell shield

FEATURES & SPECIFICATIONS

The TWX3 LED is an energy-efficient, low maintenance LED wall pack for replacing up to a 400W MH fixture, providing the same footprint on the wall. TWX3 is ideal for higher mounting height applications such as industrial buildings, warehouses and schools.

Two-piece die-cast aluminum housing to optimize thermal management through conductive and convective cooling. The door is hinged on the side and can be removed for easy installation. The housing is completely sealed against moisture and environmental contaminants (IP65) and is suitable for the hose-down applications. Exterior painted parts are protected by a zinc-infused Super Durable TGIC thermoset powder coat finish that provides superior resistance to corrosion and weathering. A tightly controlled multi-stage process ensures a 3 mils thickness for a finish that can withstand

extreme climate changes without cracking or peeling.

The advanced optical design uses both reflector and refractor technologies that work together to create superior illumination and further throw, getting the light where it is needed. The US-made borosilicate glass refractor is specifically designed to maximize light extraction and create a fully luminous luminaire for a better nighttime look.

Light engine consists of high-efficacy LEDs mounted to housing to maximize heat dissipation and promote long-life (up to L81/100,000 hours at 25°C). The electronic driver has a power factor of >90%, THD <20%.

INSTALLATION Designed for wall mounting above four feet from the ground. Housing is configured for mounting directly over a standard junction box (by others) or for surface wiring via any of three 1/2" threaded entry hubs.

LISTINGS
CSA certified to U.S. and Canadian standards. IP65 rated for outdoor applications. Rated for -40°C minimum ambient.
DesignLights Consortium® (DLC) qualified product. Not all versions of this product may be DLC qualified. Please check the DLC Qualified Products List at www.designlights.org/QPL to confirm which versions are qualified.

5-year limited warranty. This is the only warranty provided and no other statements in this specification sheet create any warranty of any kind. All other express and implied warranties are disclaimed. Complete warranty terms located at:

Note: Actual performance may differ as a result of end-user environment and application. All values are design or typical values, measured under laboratory conditions at 25 °C. Specifications subject to change without notice.



DRAWING INDEX

SHEET NO.	PLAN TITLE
1	LAND DEVELOPMENT PLAN *TO BE RECORDED*
2	EXISTING FEATURES & DEMOLITION PLAN
3	SITE GRADING, UTILITIES, & EROSION PLAN
4	LANDSCAPING PLAN
5	LIGHTING & SIGNAGE PLAN
6	CONSTRUCTION DETAILS PLAN
7	FIRE DEPT. & FIRE TRUCK TURNING PLAN

SHEET 5 OF 7

Rev. 11/30/22



LIGHTING & SIGNAGE PLAN MACADA PARTNERS 2650 LINDEN, LLC


CITY OF BETHLEHEM, NORTHAMPTON COUNTY, PA


HOP - PES **P**ROFESSIONAL ENGINEERING & SURVEYING 2705 WILLOW ST. COPLAY, PA 18037 (610-799-3935)


SCALE : 1" = 20' DATE: 16 MAY 2024

WWW.HOP-PES.COM (ROBERTHOPPESJR@GMAIL.COM) DRAWN BY: BRH DRAWING # 5-24-05E



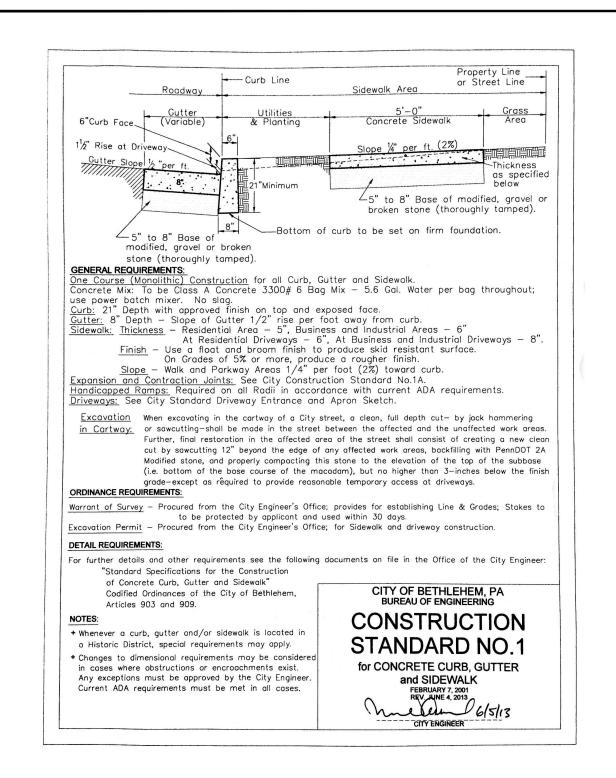

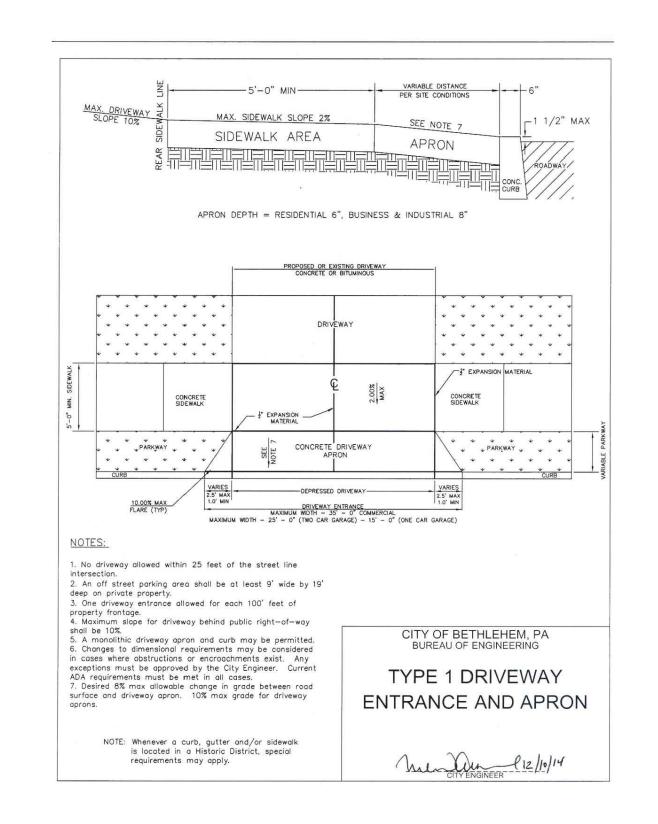

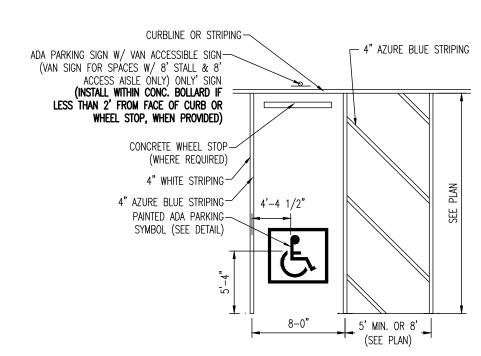


NOTES:

1. PAVEMENT STRIPING FOR ALL ADA PARKING SPACES SHALL BE PAINTED AZURE BLUE.


2. WHERE AN ADA PARKING STALL MEETS A STANDARD PARKING STALL, AN AZURE BLUE AND WHITE PAVEMENT STRIPE SHALL BE PAINTED.

3. ALL PAVEMENT STRIPING, MARKINGS AND SIGNAGE SHALL BE CONSTRUCTED IN ACCORDANCE WITH THE LATEST ADA ACCESSIBILITY GUIDELINES.

ADA STALL MARKINGS

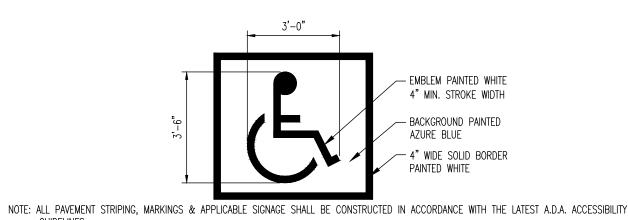


PAINTED A.D.A. PARKING SYMBOL DETAIL

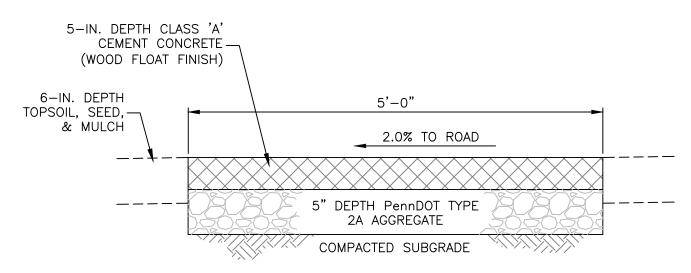

NOTES

- 1. MATERIALS AND CONSTRUCTION IN ACCORDANCE WITH SECTIONS 704 AND 1001 OF PENNDOT PUBLICATION 408.
- 2. SIDEWALK PANELS SHALL HAVE AVERAGE DIMENSIONS OF 5 FT. BY 5 FT. SQUARE.
- SIDEWALK SECTIONS SHALL BE FORMED USING MAXIMUM ONE—QUARTER (1/4) INCH THICK DIVISION PLATES OR PREMOULDED BITUM. EXPANSION JOINT MATERIAL THAT EXTENDS THE FULL DEPTH OF THE SLAB.
- 4. NOSING ON ALL EDGES SHALL BE FINISHED TO A RADIUS OF NOT MORE THAN ONE—HALF (1/2) INCH.
- 5. PLACE 1/2—INCH PREMOULDED BITUM. EXPANSION JOINT MATERIAL AT STRUCTURES (INCLUDING EXISTING SIDEWALK). TRIM MATERIAL TO CONFORM TO FINISHED SIDEWALK CROSS—SECTION.

CONCRETE SIDEWALK CROSS—SECTION NO SCALE

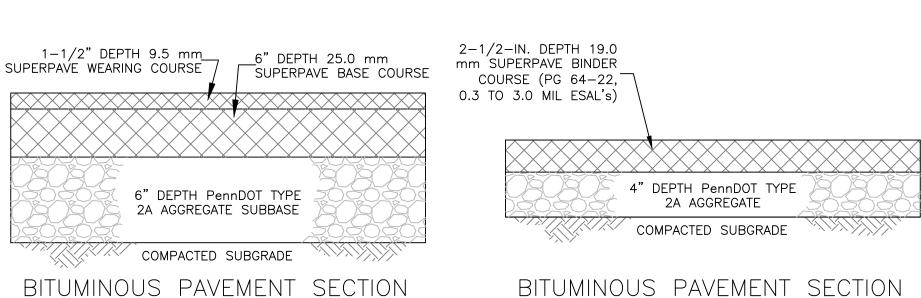

BITUMINOUS PAVEMENT SECTION
(LOCAL ROADWAY)


NO SCALE

BITUMINOUS PAVEMENT SECTI (PRIVATE DRIVEWAY)

NO SCALE

TRAFFIC COUNTS PER 9TH EDITION OF ITE TRIP GENERATION MANUAL


Description/ITE Code	Units	ITE	1 -						Expected Units	Total Generated Trips			Total Distribution of Generated Trips						
		Weekday	AM	PM	Pass-By	AM In	AM Out	PM In	PM Out		Daily	AM Hour	PM Hour	AM In	AM Out	Pass-By	PM In	PM Out	Pass-By
Apartment 220	DU	6.65	0.51	0.62		20%	80%	65%	35%	8.0	53	4	5	1	3	0	3	2	0

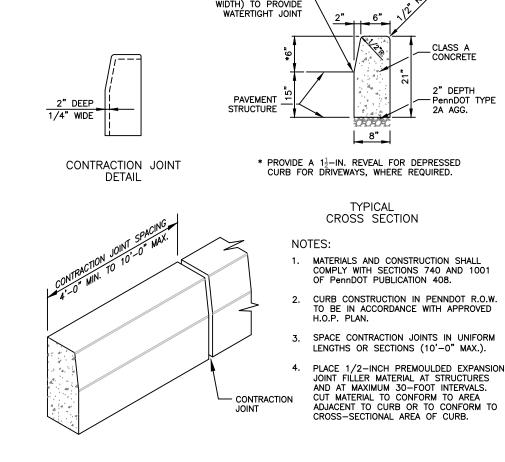

SEAL ALONG CURB W/ PG 64-22 SEALANT (12-IN.


PLAIN CEMENT CONCRETE CURB DETAIL

NO SCALE

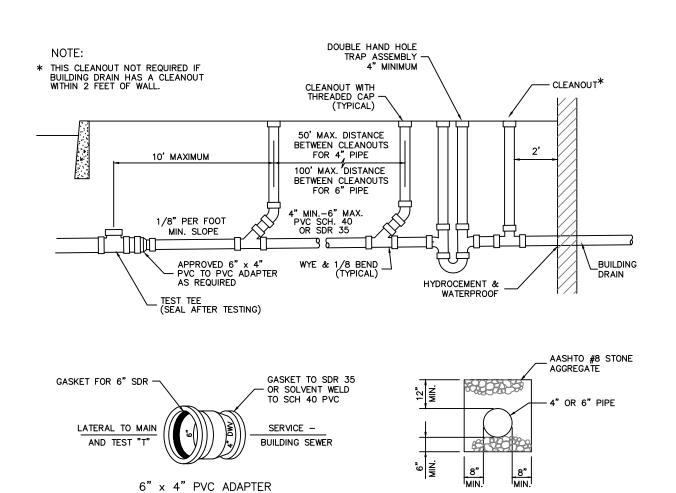


SANITARY SEWER LATERAL DETAIL

NO SCALE

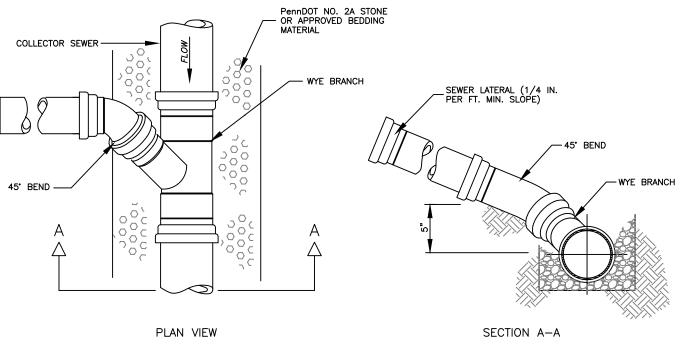


SANITARY SEWER LATERAL CONNECTION DETAIL

NO SCALE

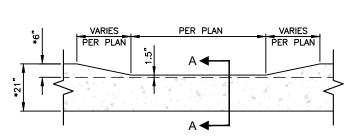

DEPRESSED CURB - FRONT ELEVATION

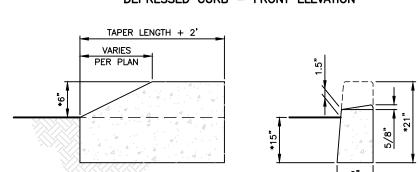

TAPERED END SECTION DEPRESSED CURB - SECTION 'A-A'

NOTES:

REV.

- 1. EXISTING CURB REMOVAL SHALL BE IN COMPLETE SECTIONS (JOINT TO JOINT),
- PROVIDE MATERIALS AND CONSTRUCTION IN ACCORDANCE WITH PennDOT SPECIFICATIONS AND PUBLICATION 408, SECTION 830, CURRENT EDITION.
- 3. SPACE CONTRACTION JOINTS IN UNIFORM LENGTHS OR SECTIONS (4'-0" MIN.
- 4. PLACE 1/2-INCH PREMOULDED EXPANSION JOINT FILLER MATERIAL AT STRUCTURES AND AT THE END OF THE WORK DAY. CUT MATERIAL TO CONFORM TO AREA ADJACENT TO CURB OR TO CONFORM TO CROSS-SECTIONAL AREA OF CURB.
- 5. SPACE EXPANSION JOINTS AT 30—FOOT INTERVALS OR AS OTHERWISE DIRECTED BY THE TOWNSHIP.
- DIRECTED BY THE TOWNSHIP.

 * PROVIDE 24-IN. HIGH CURB, 8-IN. REVEAL, 16-IN. DEPTH BELOW FINISHED ROAD GRADE WITHIN PennDOT RIGHTS-OF-WAY IN ACCORDANCE WITH THE APPROVED HIGHWAY OCCUPANCY PERMIT FOR THE PROJECT, AS APPLICABLE.
- PLAIN CEMENT CONCRETE CURB DETAILS

 NO SCALE


1 CITY OF BETHLEHEM REVIEW LETTER


|BRH|REH|

BY CHK

10/16/24

DATE

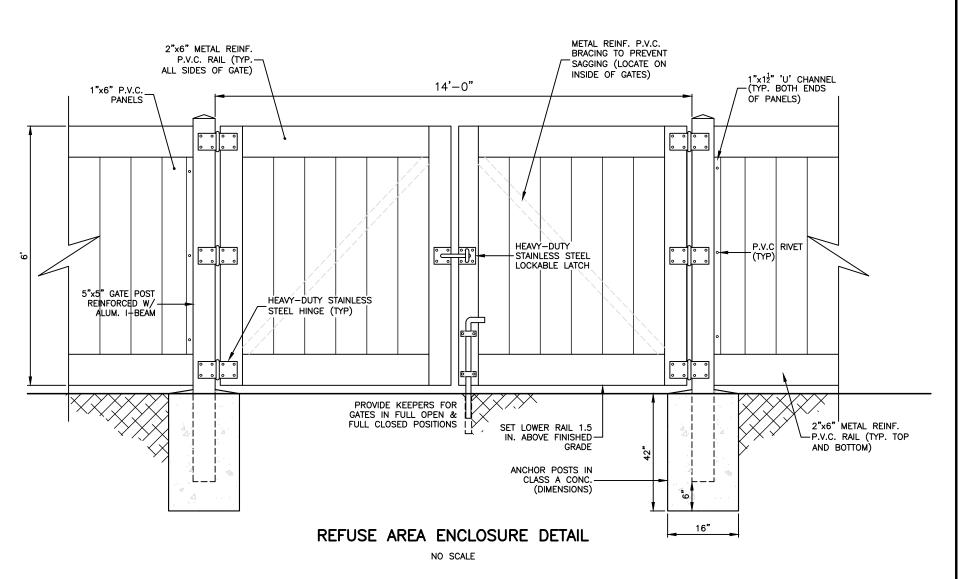

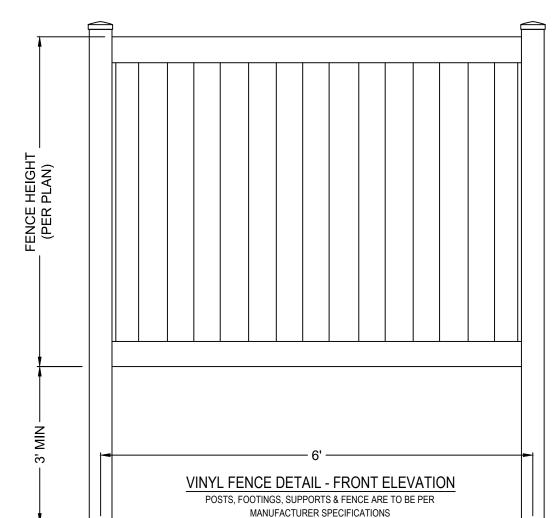

	DRAWING INDEX
SHEET NO.	PLAN TITLE
1	LAND DEVELOPMENT PLAN *TO BE RECORDED*
2	EXISTING FEATURES & DEMOLITION PLAN
3	SITE GRADING, UTILITIES, & EROSION PLAN
4	LANDSCAPING PLAN
5	LIGHTING & SIGNAGE PLAN
6	CONSTRUCTION DETAILS PLAN
7	FIRE DEPT. & FIRE TRUCK TURNING PLAN

CONSTRUCTION DETAILS PLAN
e or write error (BETTMES TELM)

MACADA PARTNERS 2650 LINDEN, LLC

HOP - PES
PROFESSIONAL
ENGINEERING & SURVEYING

ENGINEERING & SURVEYING
2705 WILLOW ST. COPLAY, PA 18037 (610-799-3935)
WWW.HOP-PES.COM (ROBERTHOPPESJR@GMAIL.COM)

SCALE: 1" = 20'

DRAWN BY: BRH

DRAWING # 5-24-05F

DATE: 16 MAY 2024



